Terramor Catskills

NY Route 212, Saugerties, NY 12477


PREPARED FOR:

TERRAMOR

550 N 31st Street Billings, MT 59101 (202) 689-7771 SUBMISSION:

SITE PLAN APPLICATION


July 1, 2022

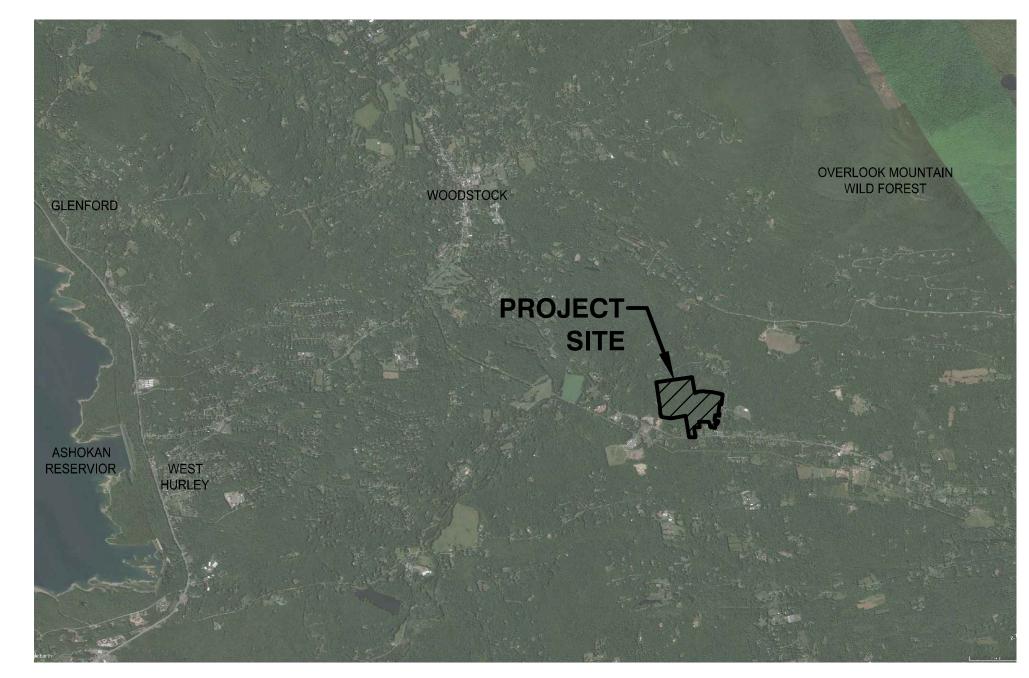





SCALE: N.T.S.

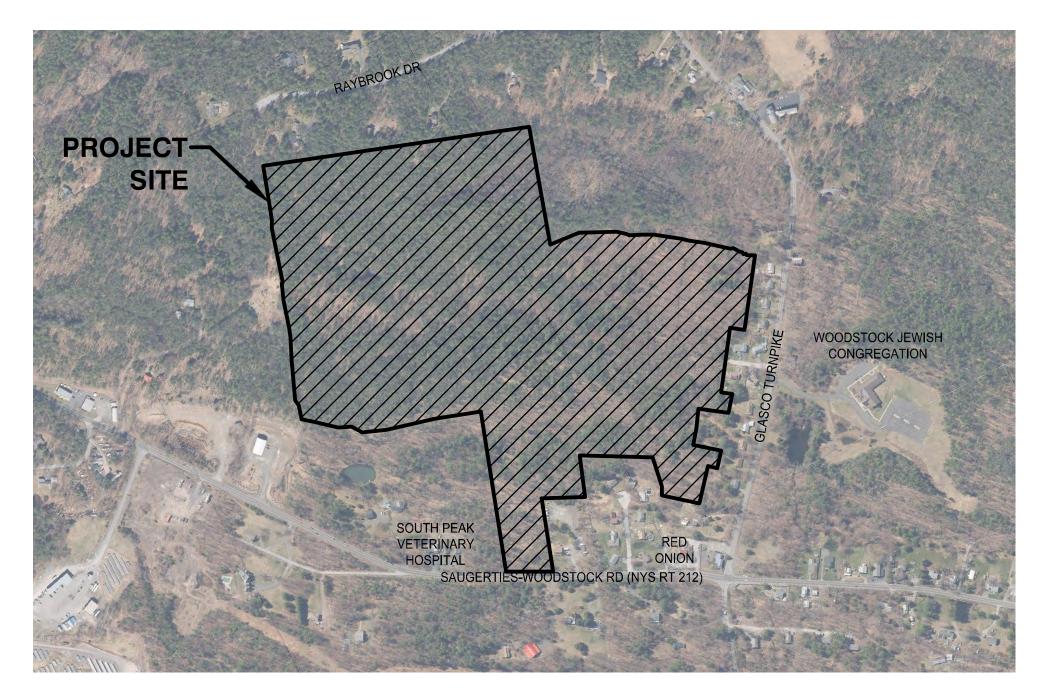

PROJECT VICINITY MAP



SCALE: 1"=500'

PREPARED BY:



CIVIL ENGINEER:



ARCHITECT:



TRAFFIC ENGINEER:



SURVEYOR:




SHEET INDEX:


_		
	SURVEY	
-	1 OF 5	BOUNDARY SURVEY
	2-5 OF 5	BOUNDARY AND TOPOGRAPHIC SURVEY
_	LANDSCAPE	ARCHITECTURE
	L-0.0	NOTES
	L-1.0	EXISTING CONDITIONS
	L-1.1	SOIL INVENTORY
	L-2.0	PROJECT MASTER PLAN
	L-3.0	OVERALL SITE ACCESS: CLEARING
	L-3.1 - 3.9	SITE PREPARATION, EROSION & SEDIMENT CONTROL PLAN
	L-4.0 - 4.9	SITE GRADING & DRAINAGE PLAN
	L-5.1 - 5.9	SITE LAYOUT, MATERIALS, AND PLANTING PLAN
	L-6.0 - 6.4	ROAD PROFILES
	L-7.1 - 7.3	SITE LIGHTING PLAN
	L-8.0 - 8.6	SITE DETAILS
_	ARCHITECT	URE
	A200	LODGE PLAN
	A201	LODGE ELEVATIONS


ARCHITECT	URE
A200	LODGE PLAN
A201	LODGE ELEVATIONS
PL200	LODGE LIGHTING
A202	WELCOME CENTER PLANS
A203	WELCOME CENTER ELEVATIONS
PL202	WELCOME CENTER LIGHTING
A204	MAINTENANCE PLANS
A205	MAINTENANCE ELEVATIONS
PL204	MAINTENANCE LIGHTING
A206	PAVILION PLANS & ELEVATIONS
A207	WELLNESS TENT PLANS & ELEVATIONS
PL207	WELLNESS TENT LIGHTING
A208	CABANA PLANS & ELEVATIONS
PL208	CABANA LIGHTING
A209	GM HOUSE PLANS & ELEVATIONS
PL209	GM HOUSE LIGHTING
A210	DORM PLANS & ELEVATIONS
PL210	DORM LIGHTING
A211	STUDIO PLANS & ELEVATIONS
PL211	STUDIO LIGHTING
A212	MESS HALL PLANS & ELEVATIONS
PL212	MESS HALL LIGHTING
A213	TENT 1 PLANS & ELEVATIONS
A214	TENT 2 PLANS & ELEVATIONS


SEWER AND WATER ENGINEERING

C1.1	UTILITY SITE PLAN
C1.1	UTILITY SITE PLAN
C1.1	UTILITY SITE PLAN
C5.1	TYPICAL WATER DETAILS
C5.2	TYPICAL SEWER DETAILS
C5.3	TYPICAL SEWER DETAILS
C5.4	TYPICAL SEWER DETAILS

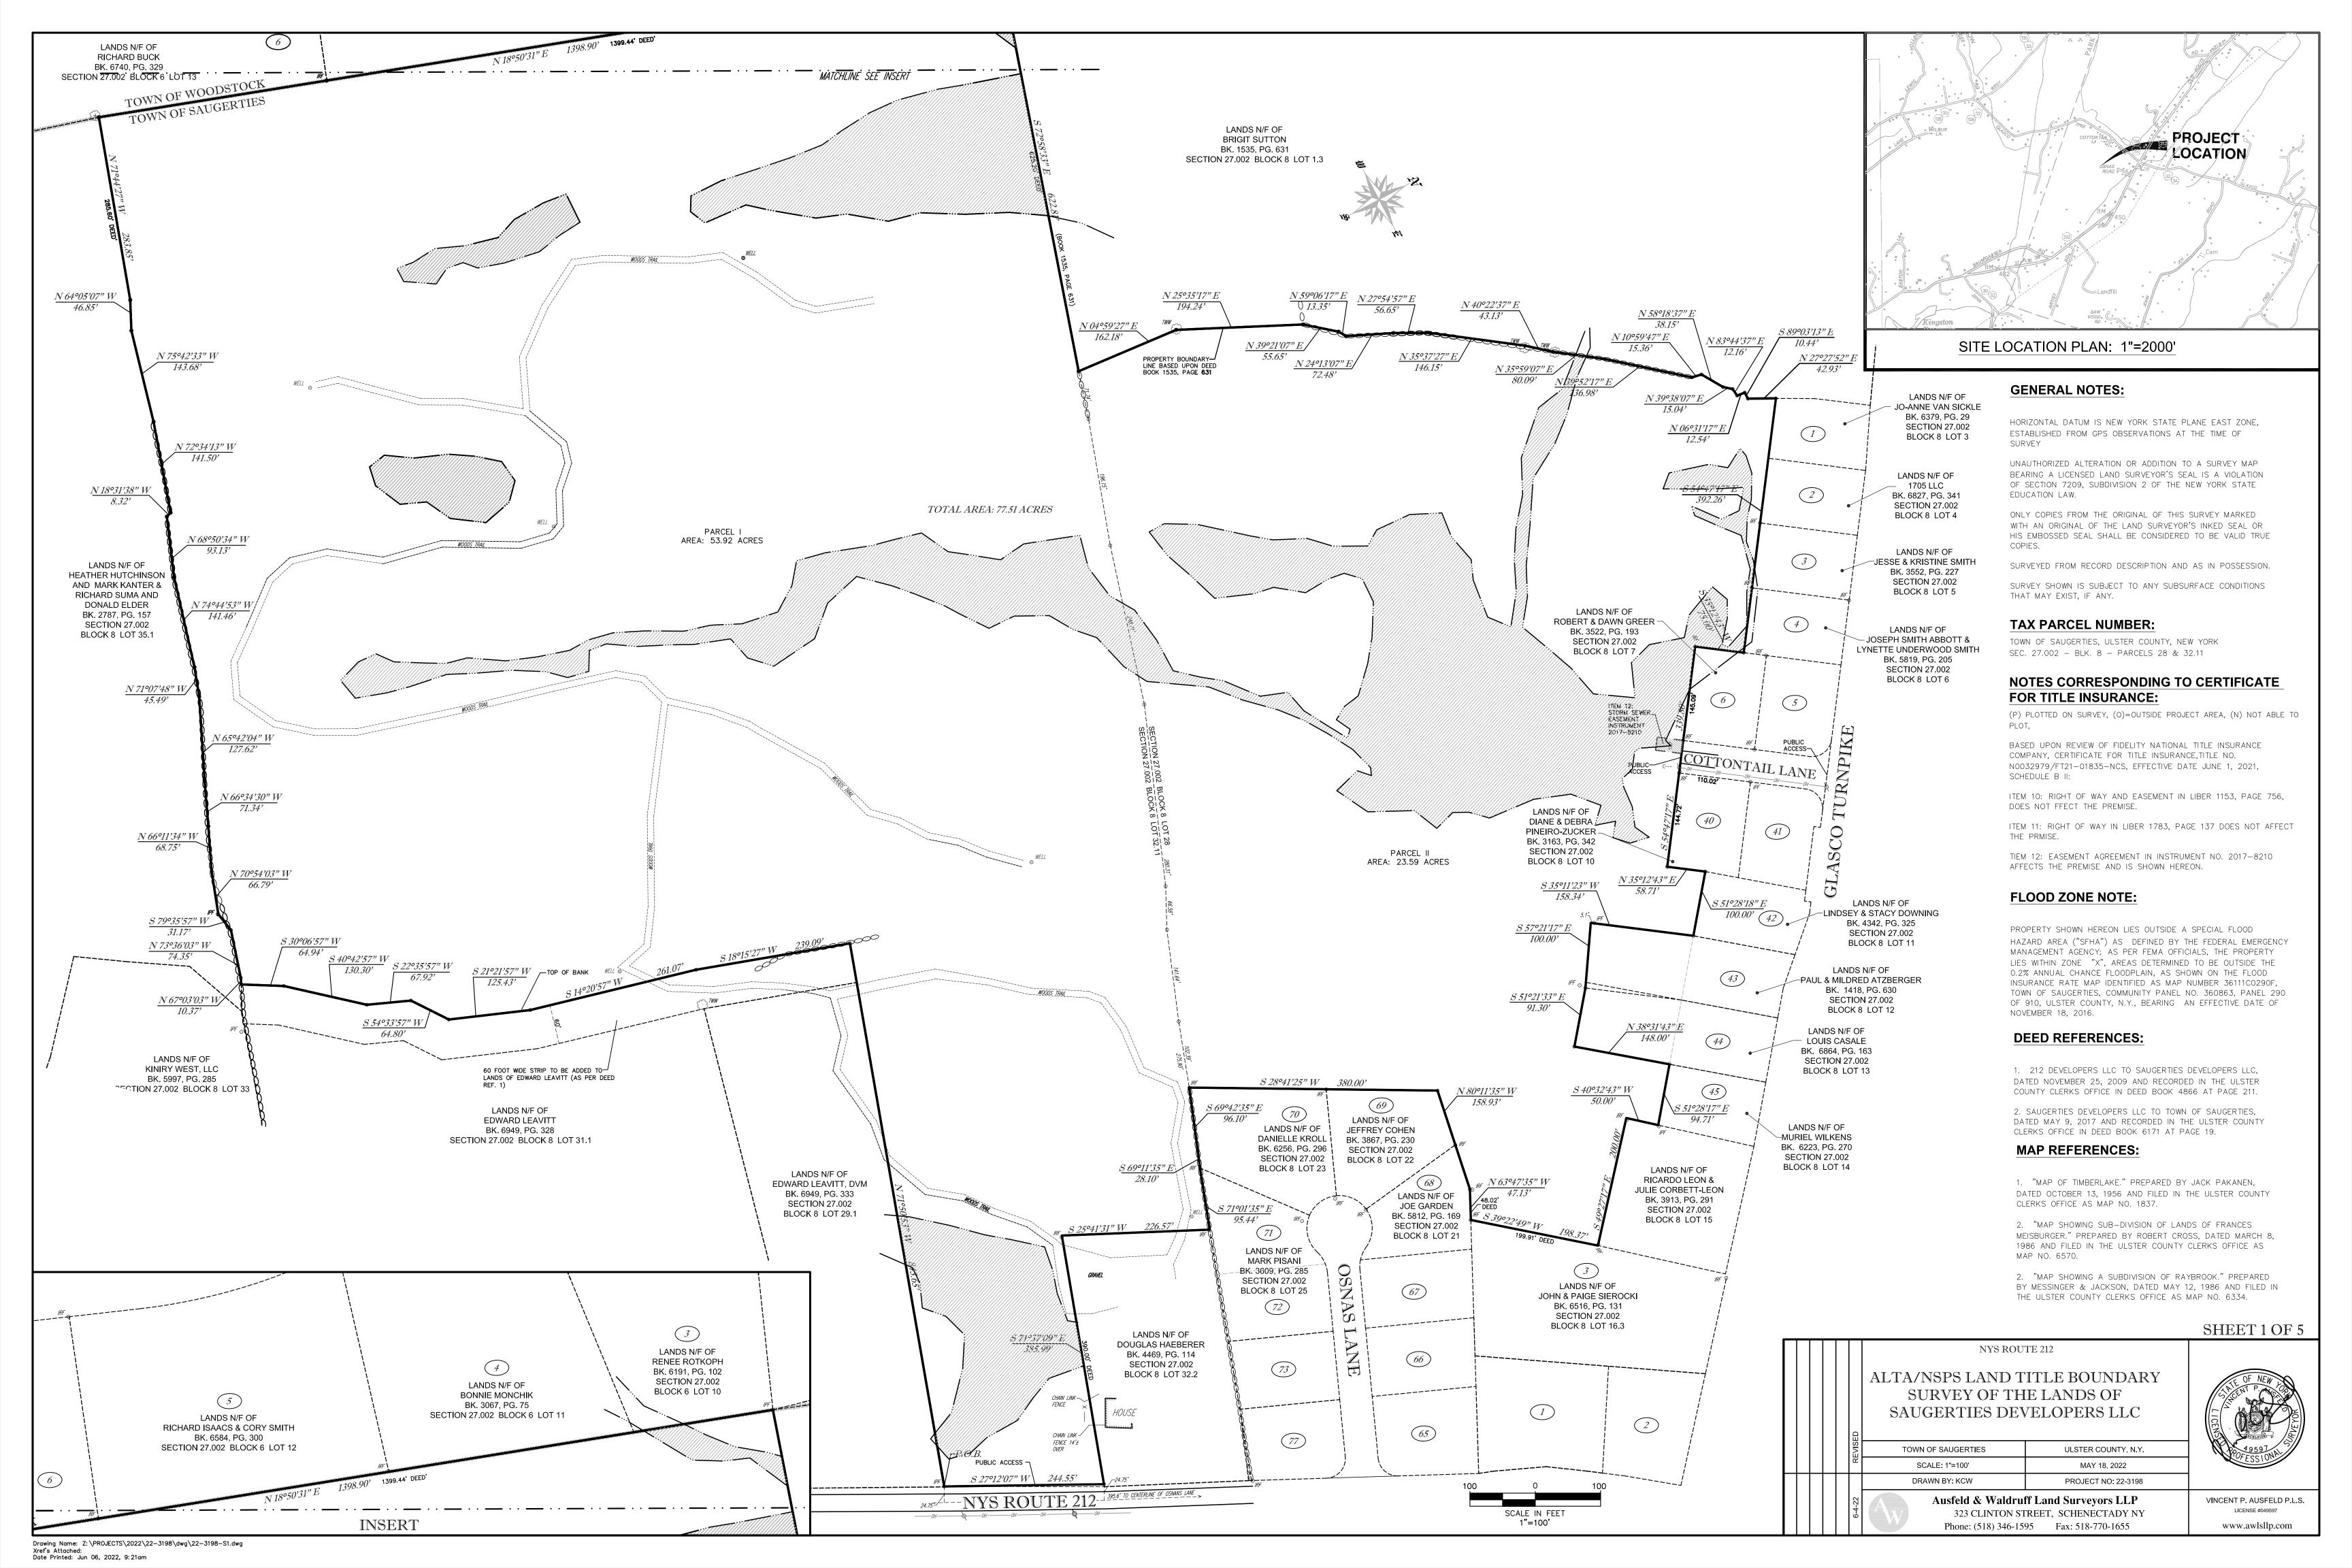

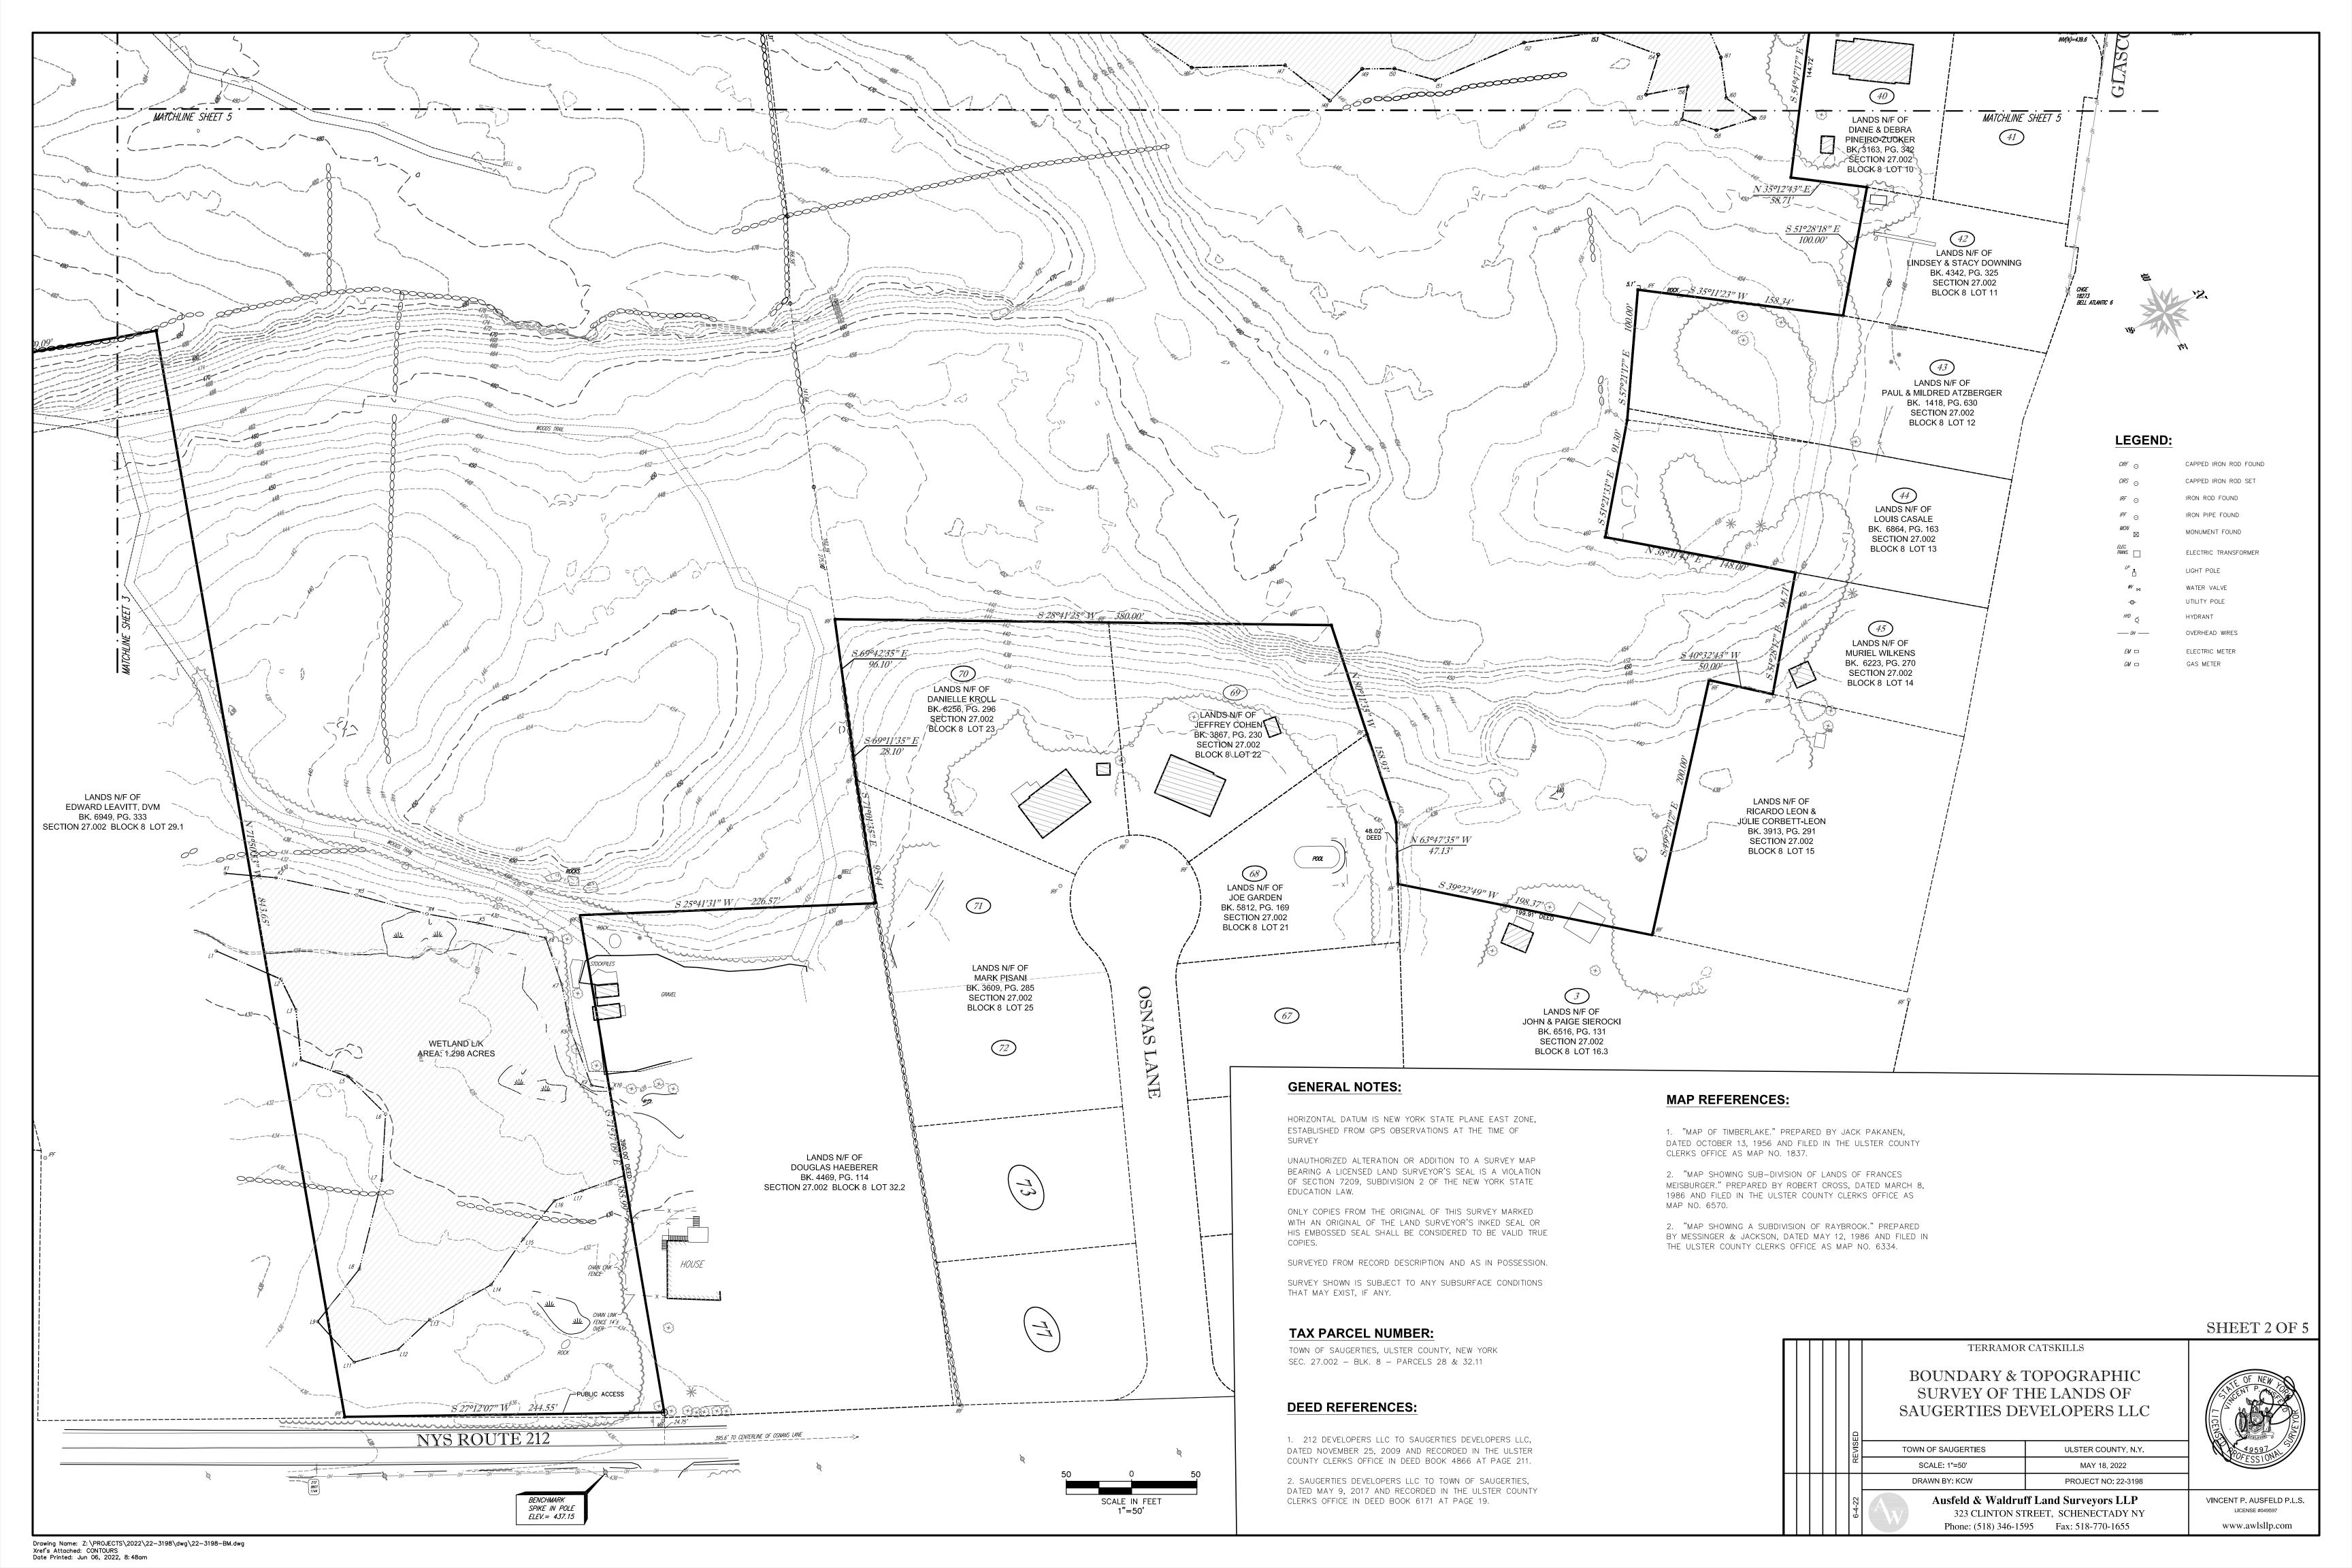

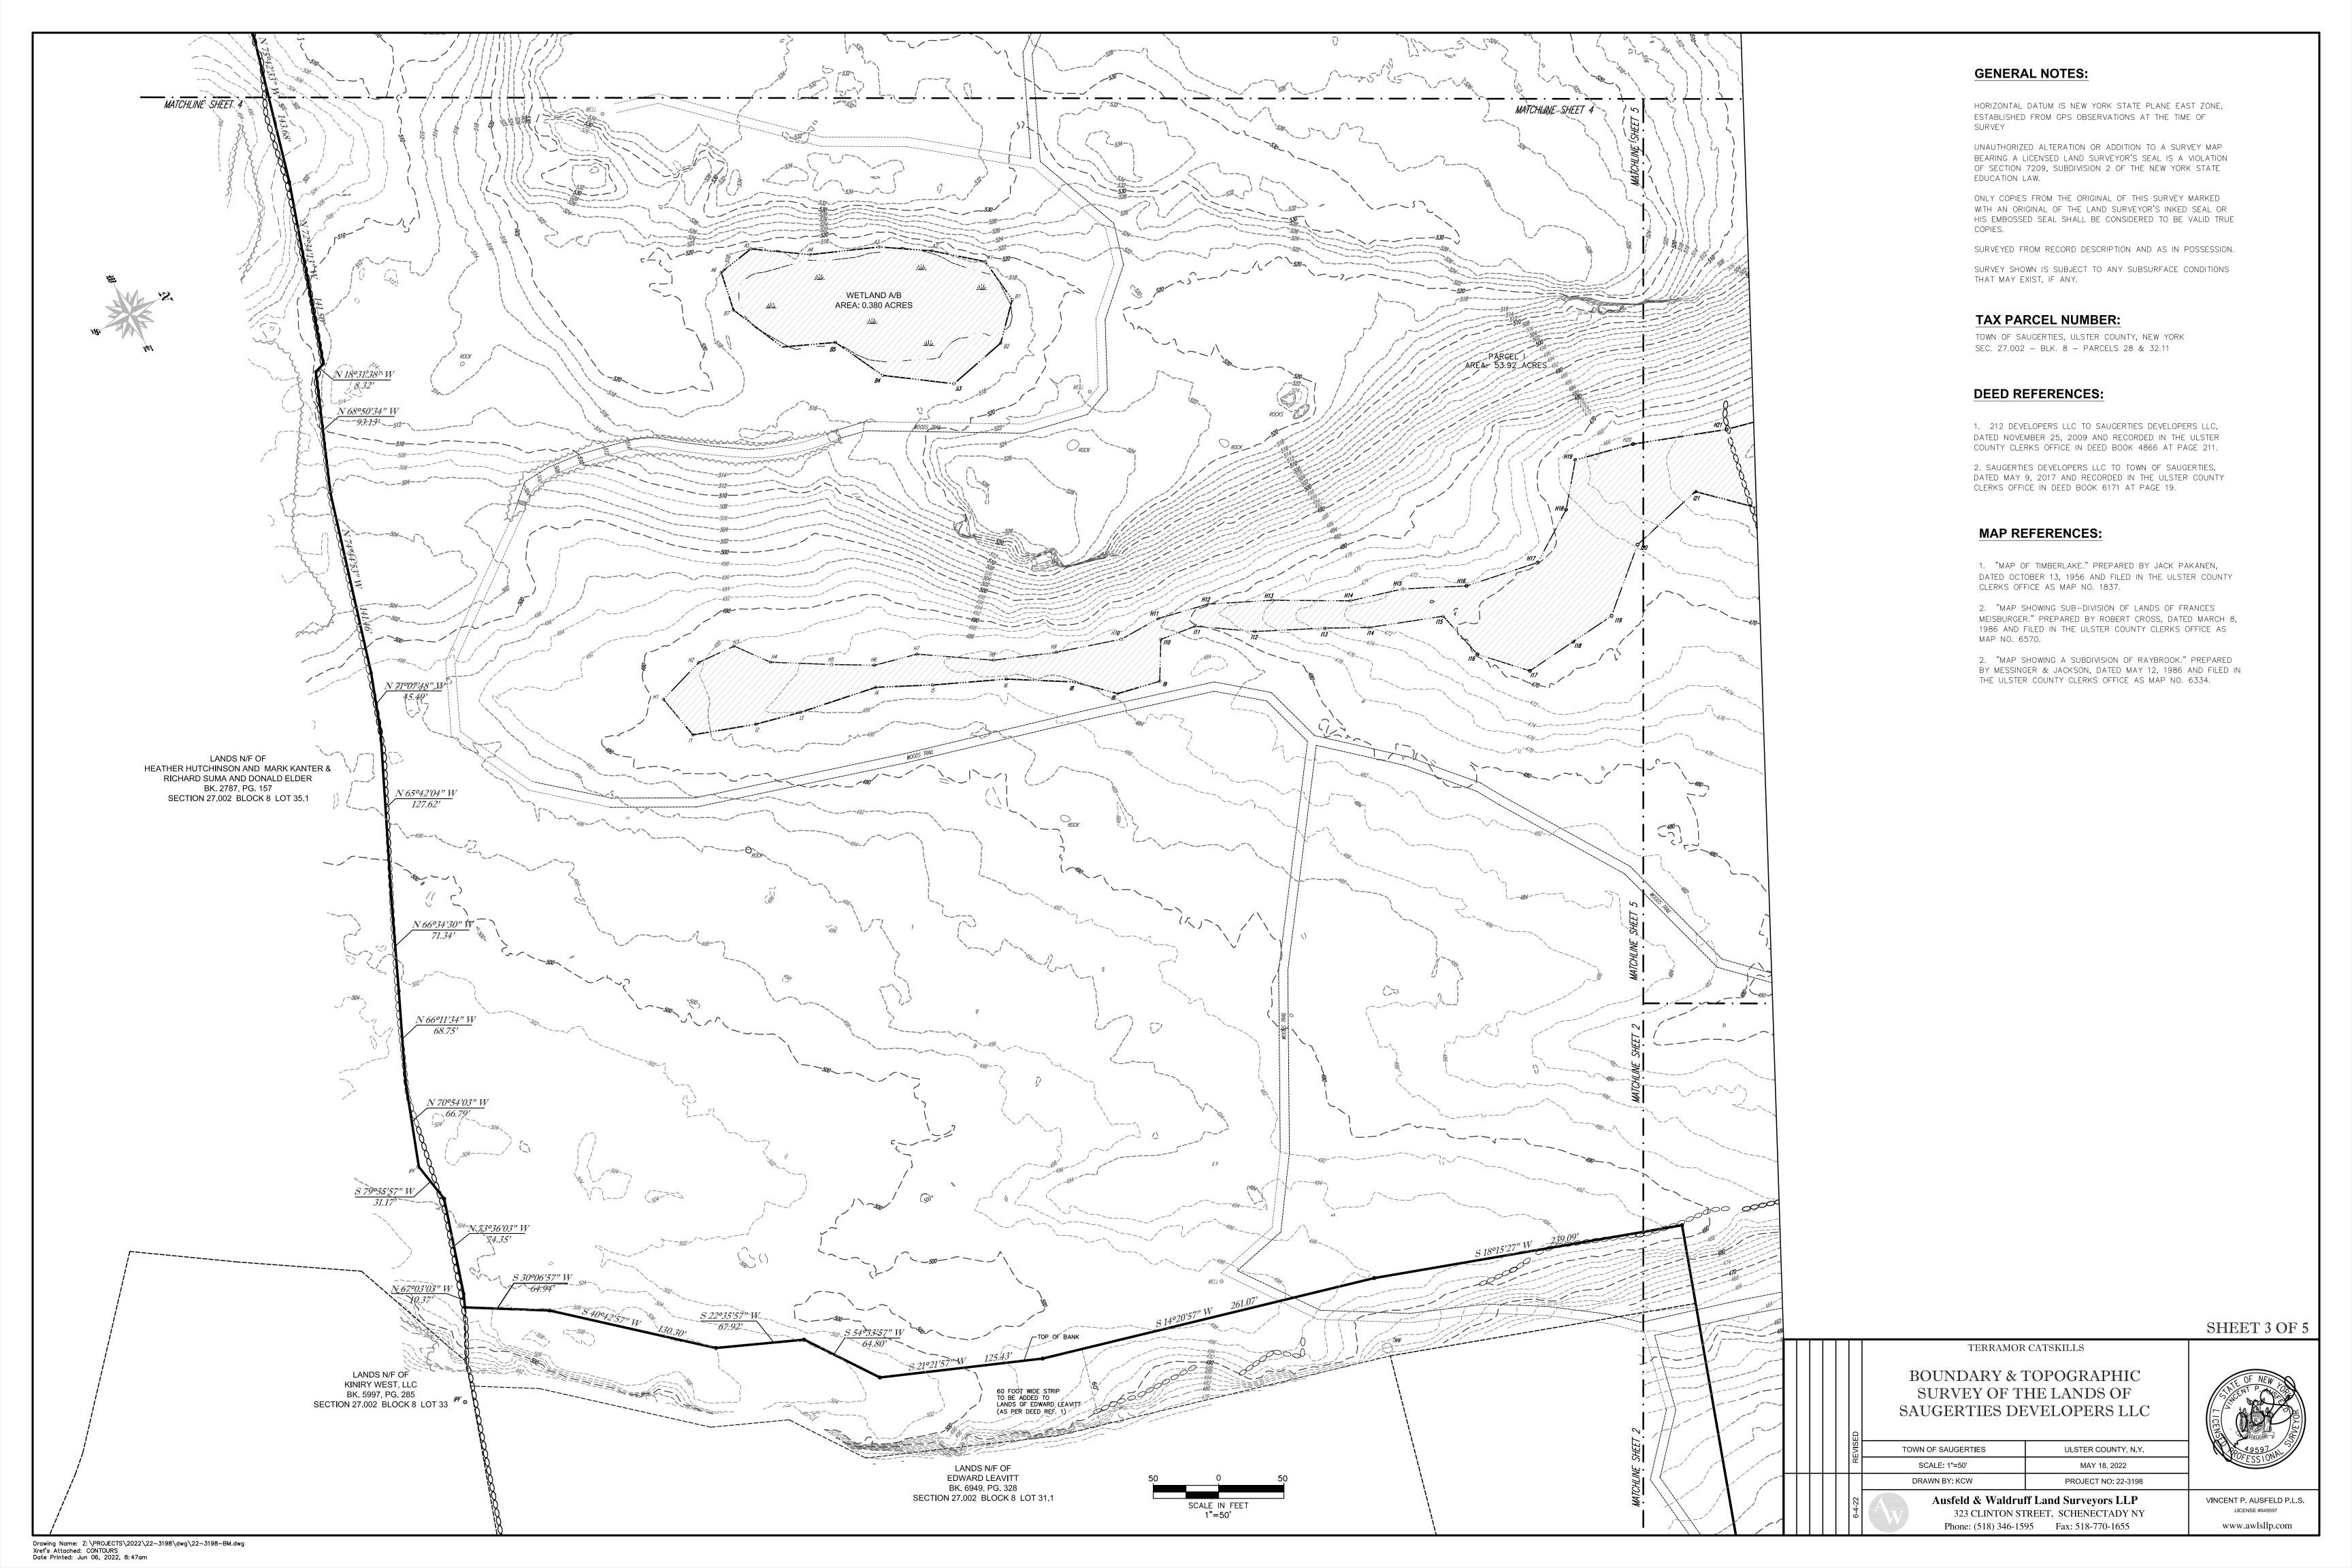

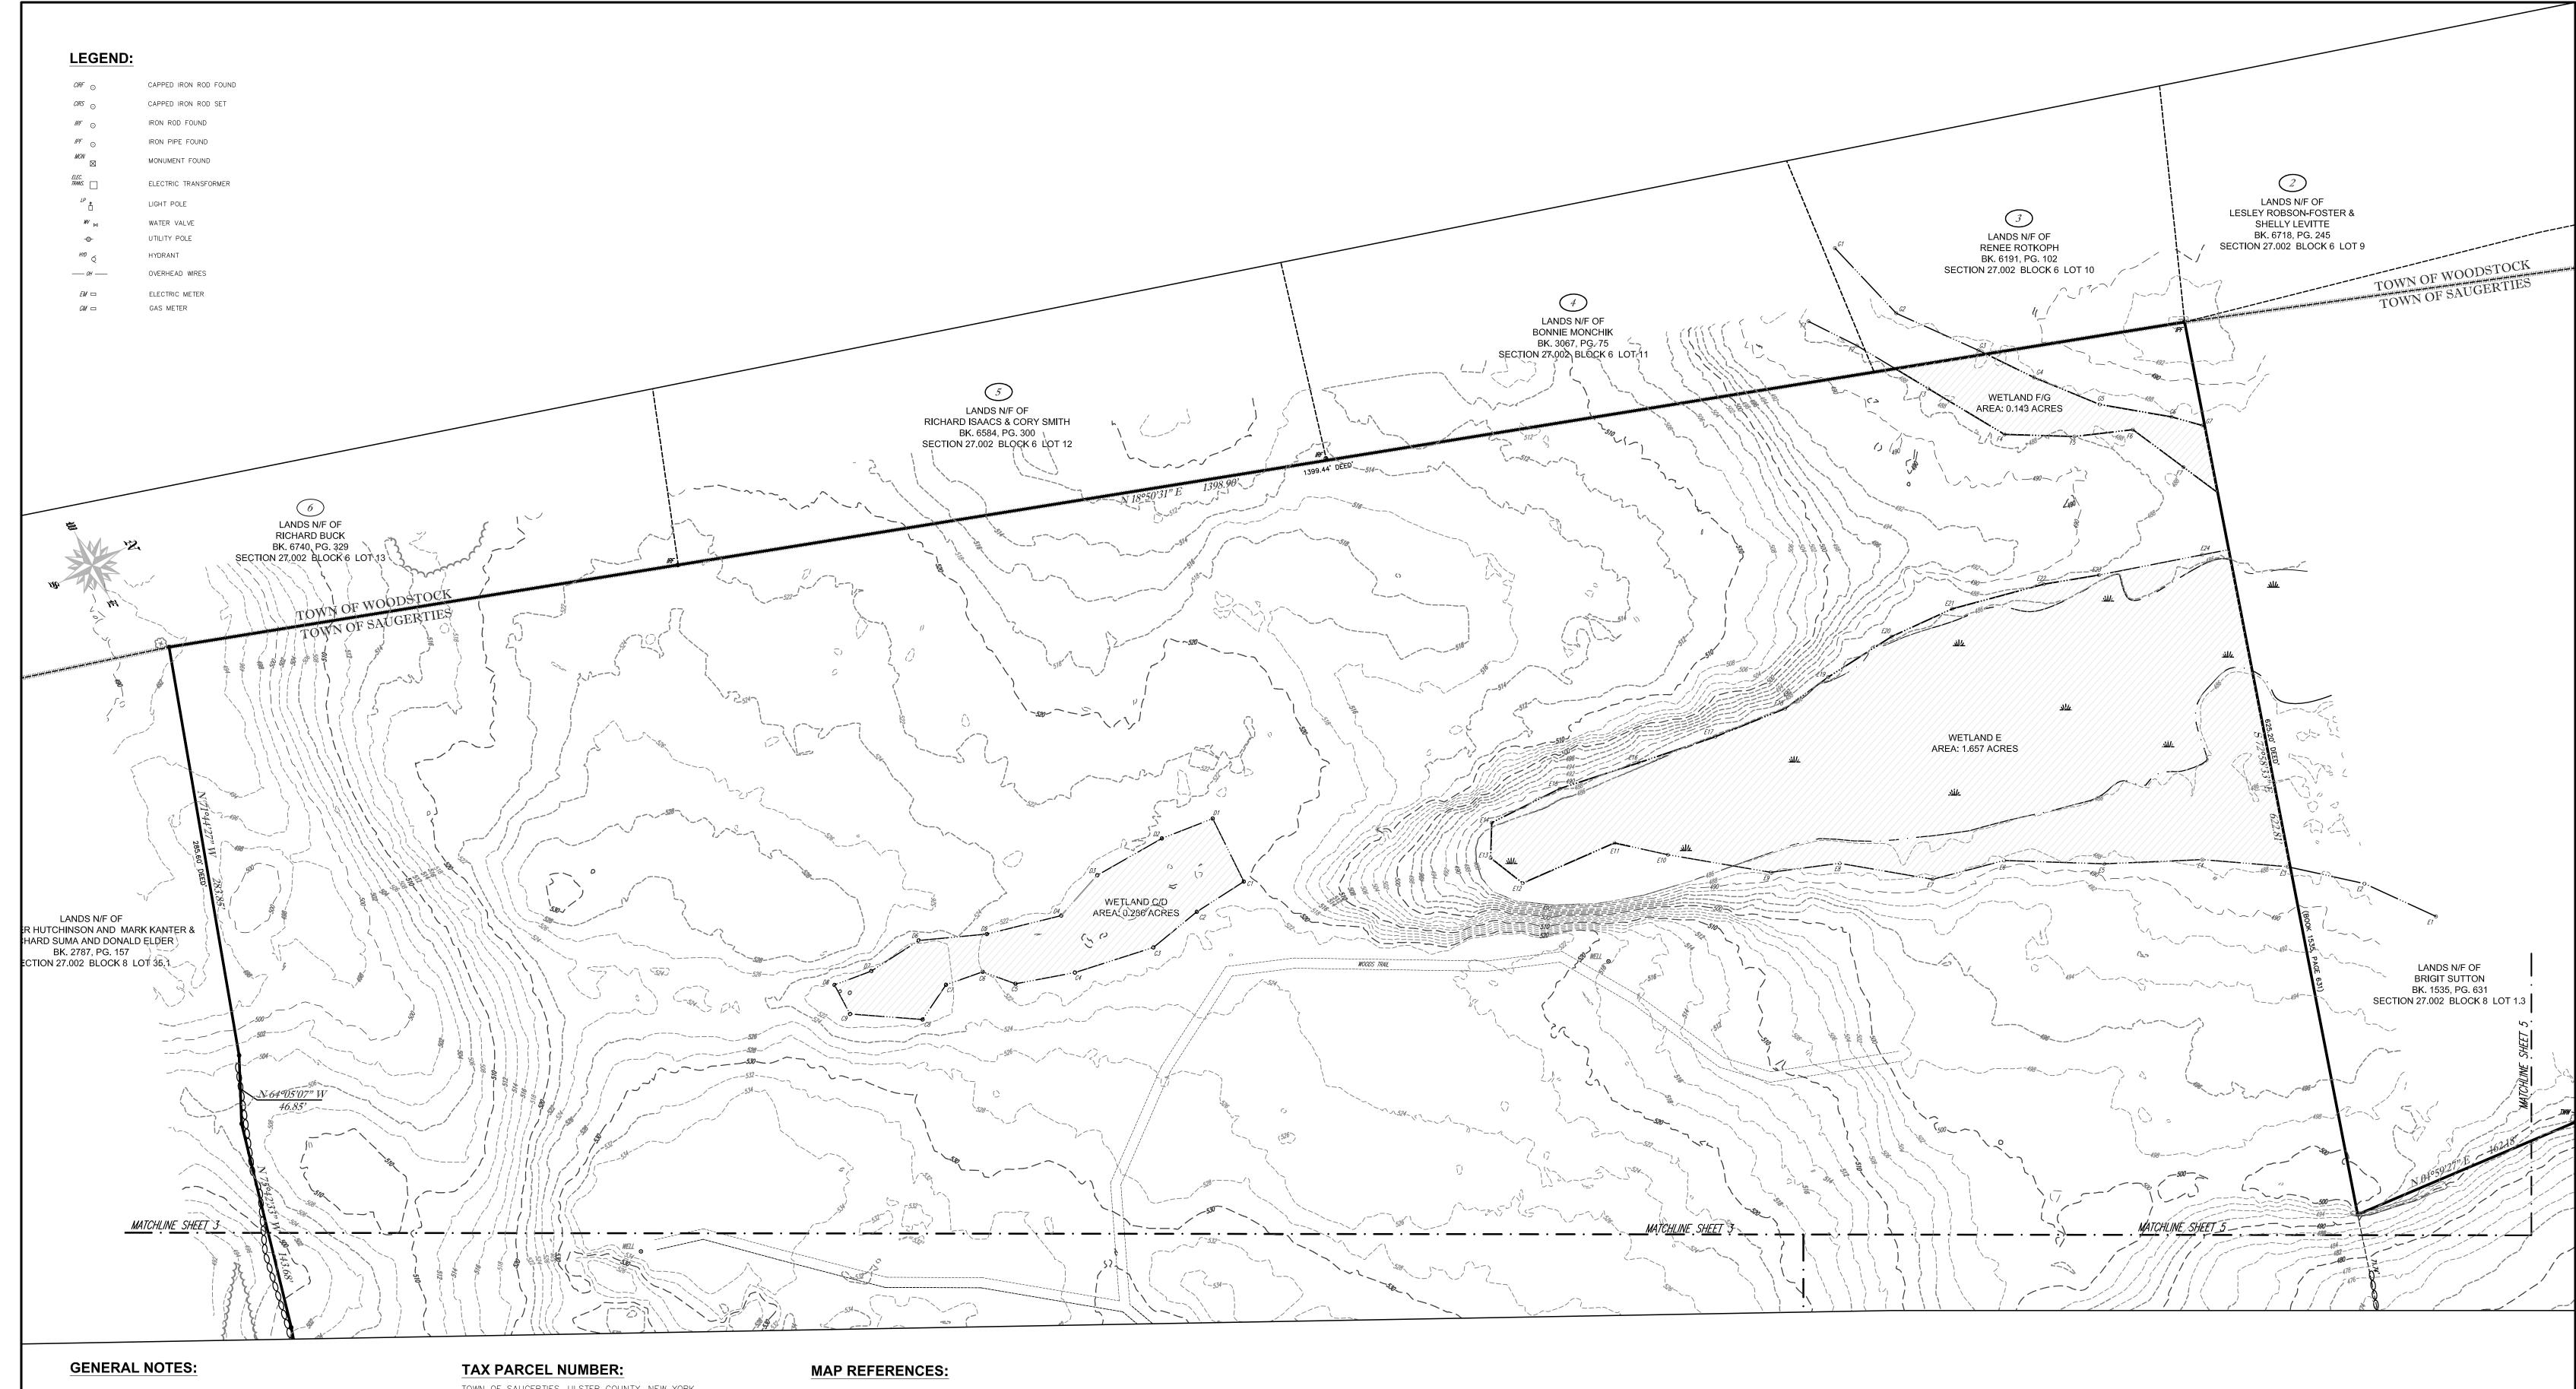

HORIZONTAL DATUM IS NEW YORK STATE PLANE EAST ZONE, ESTABLISHED FROM GPS OBSERVATIONS AT THE TIME OF

UNAUTHORIZED ALTERATION OR ADDITION TO A SURVEY MAP BEARING A LICENSED LAND SURVEYOR'S SEAL IS A VIOLATION OF SECTION 7209, SUBDIVISION 2 OF THE NEW YORK STATE EDUCATION LAW.

ONLY COPIES FROM THE ORIGINAL OF THIS SURVEY MARKED WITH AN ORIGINAL OF THE LAND SURVEYOR'S INKED SEAL OR HIS EMBOSSED SEAL SHALL BE CONSIDERED TO BE VALID TRUE

SURVEYED FROM RECORD DESCRIPTION AND AS IN POSSESSION.

SURVEY SHOWN IS SUBJECT TO ANY SUBSURFACE CONDITIONS THAT MAY EXIST, IF ANY.

TOWN OF SAUGERTIES, ULSTER COUNTY, NEW YORK SEC. 27.002 — BLK. 8 — PARCELS 28 & 32.11

DEED REFERENCES:

 212 DEVELOPERS LLC TO SAUGERTIES DEVELOPERS LLC, DATED NOVEMBER 25, 2009 AND RECORDED IN THE ULSTER COUNTY CLERKS OFFICE IN DEED BOOK 4866 AT PAGE 211.
 SAUGERTIES DEVELOPERS LLC TO TOWN OF SAUGERTIES,


CLERKS OFFICE IN DEED BOOK 6171 AT PAGE 19.

DATED MAY 9, 2017 AND RECORDED IN THE ULSTER COUNTY

1. "MAP OF TIMBERLAKE." PREPARED BY JACK PAKANEN, DATED OCTOBER 13, 1956 AND FILED IN THE ULSTER COUNTY CLERKS OFFICE AS MAP NO. 1837.

2. "MAP SHOWING SUB-DIVISION OF LANDS OF FRANCES MEISBURGER." PREPARED BY ROBERT CROSS, DATED MARCH 8, 1986 AND FILED IN THE ULSTER COUNTY CLERKS OFFICE AS MAP NO. 6570.


2. "MAP SHOWING A SUBDIVISION OF RAYBROOK." PREPARED BY MESSINGER & JACKSON, DATED MAY 12, 1986 AND FILED IN THE ULSTER COUNTY CLERKS OFFICE AS MAP NO. 6334.

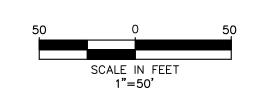

SITE ADDRESS:

TAX MAP PARCEL 28: COTTONTAIL LANE SAUGERTIES, NY 12477

TAX MAP PARCEL 32.11: NEW YORK STATE ROUTE 212 SAUGERTIES, N.Y. 12477

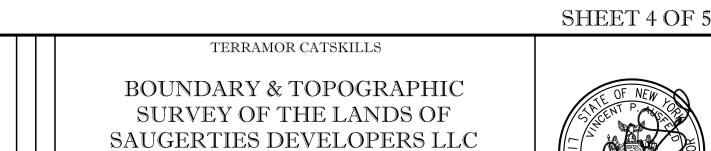


TOWN OF SAUGERTIES ULSTER COUNTY, N.Y.

SCALE: 1"=50' MAY 18, 2022

DRAWN BY: KCW PROJECT NO: 22-3198

Ausfeld & Waldruff Land Surveyors LLP
323 CLINTON STREET, SCHENECTADY NY
Phone: (518) 346-1595 Fax: 518-770-1655

VINCENT P. AUSFELD P.L.S. LICENSE #049597 WWW.awlsllp.com

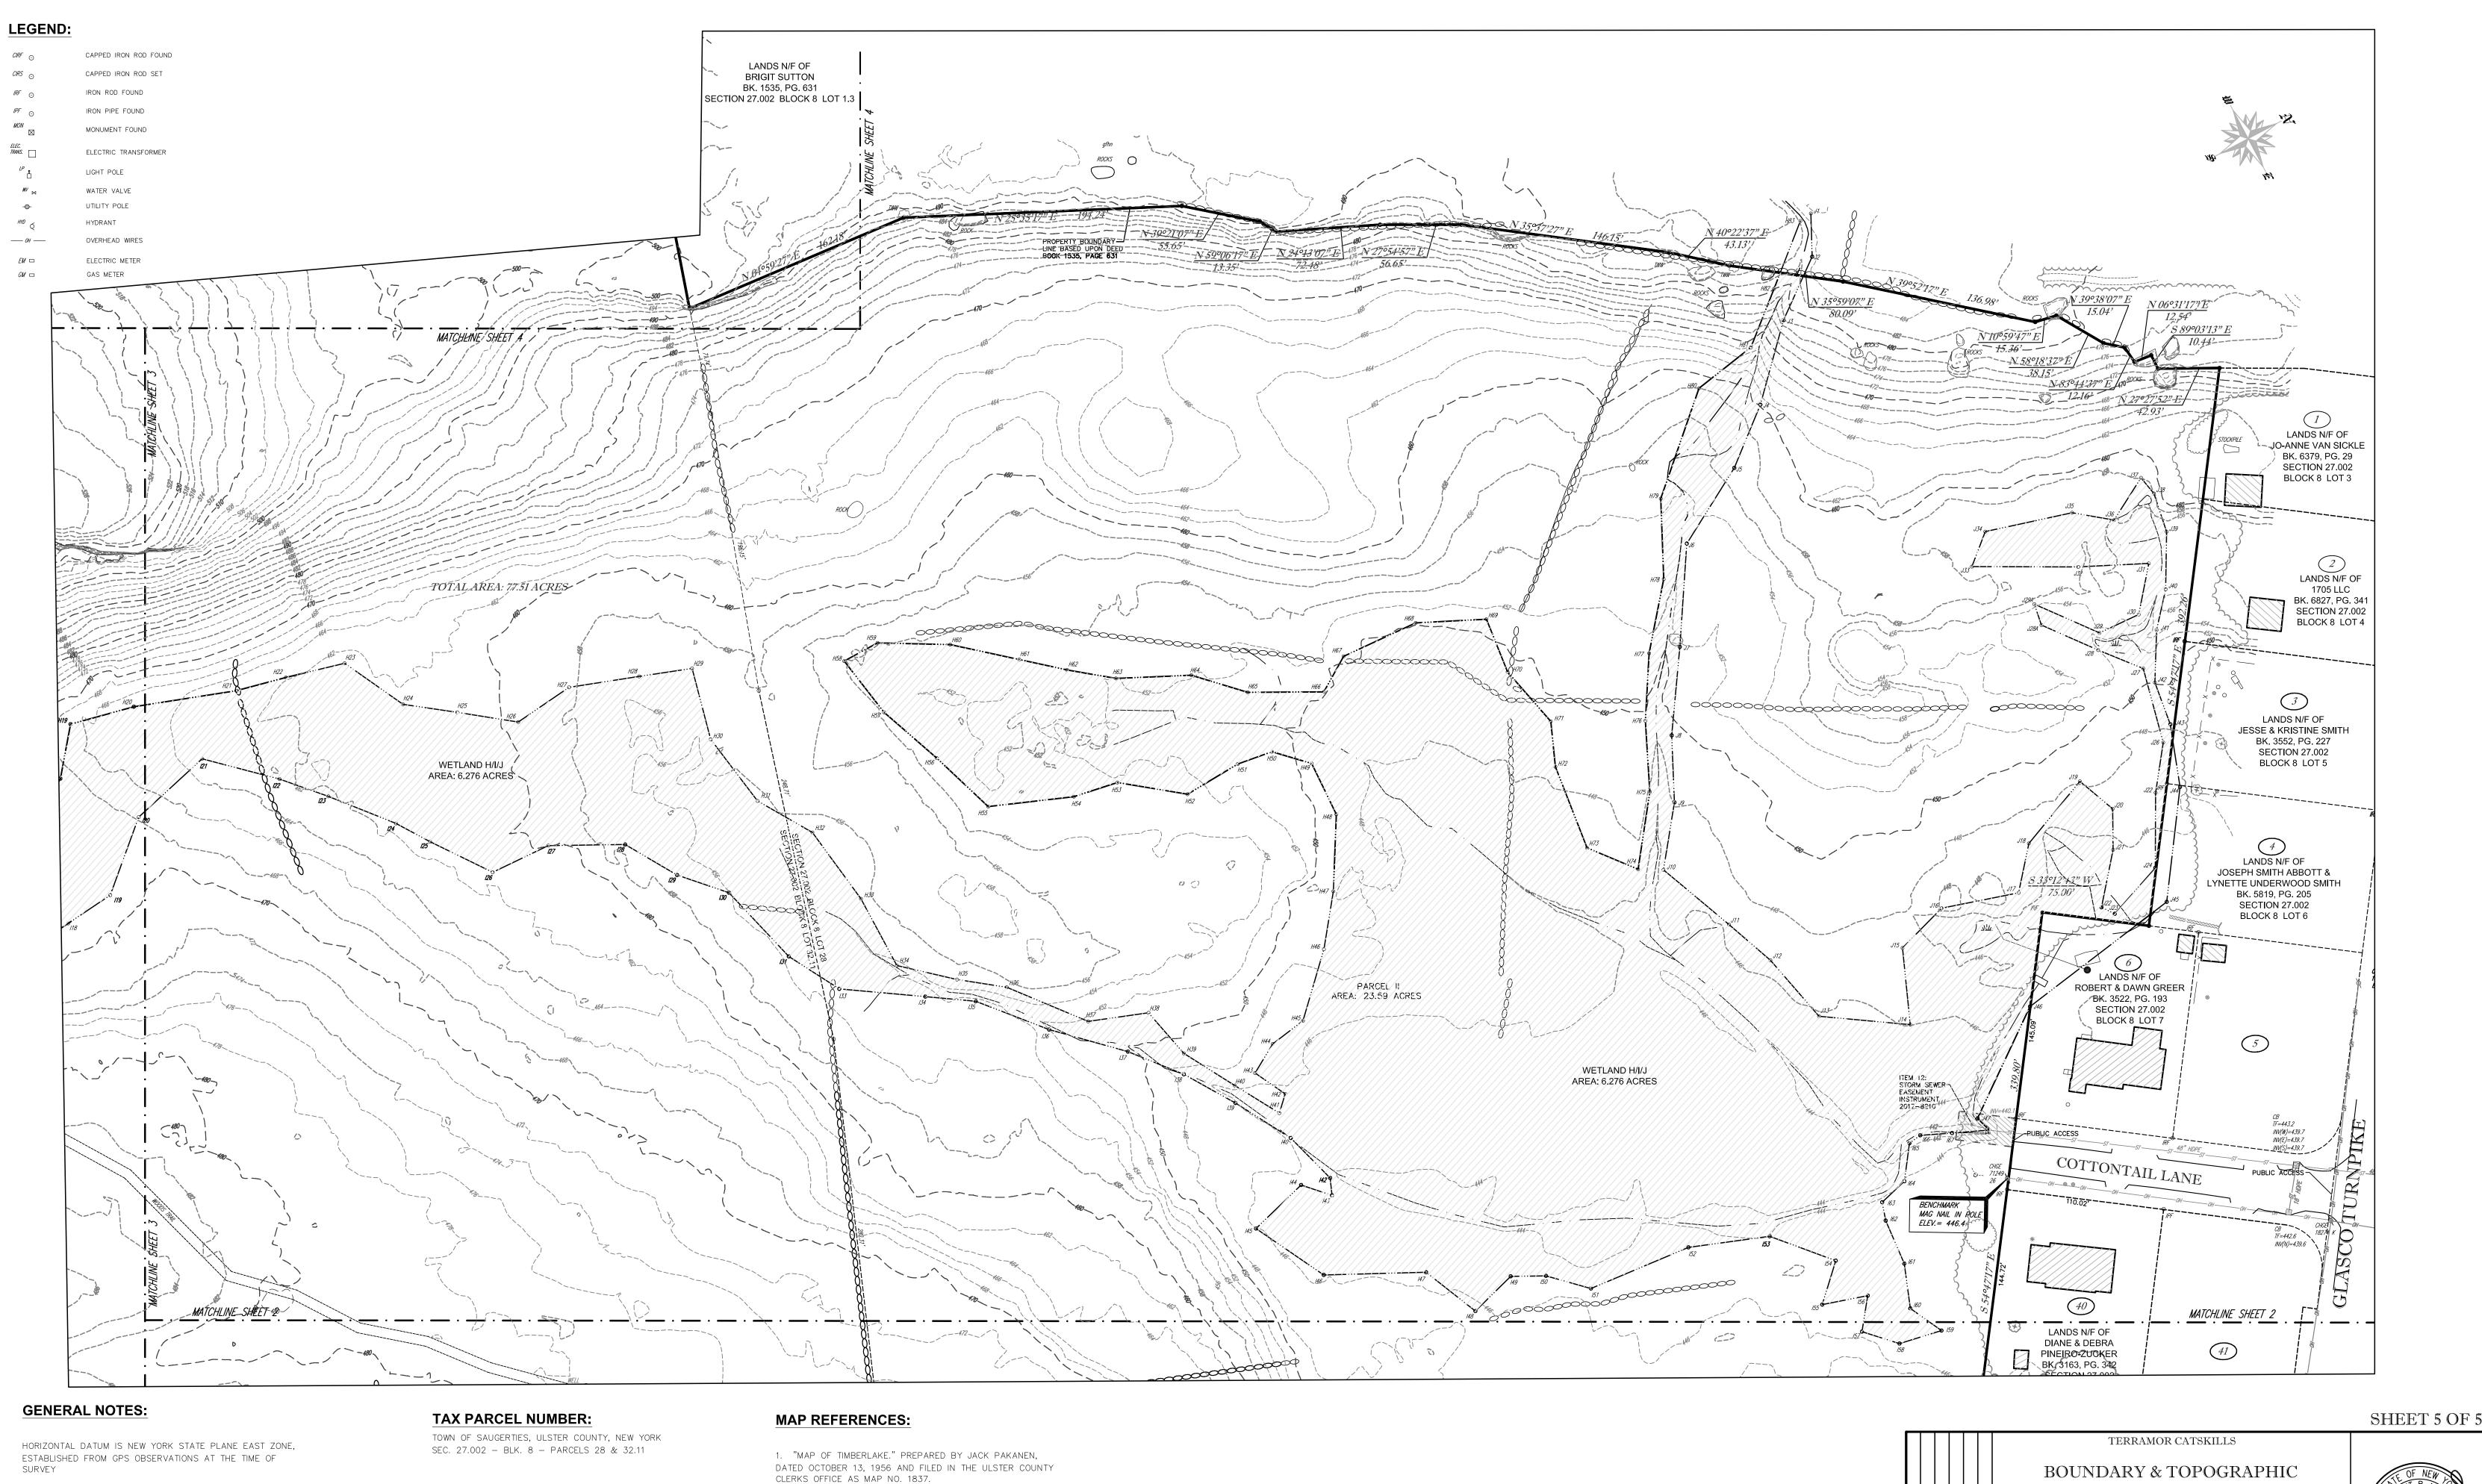

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SITE ADDRESS:

TAX MAP PARCEL 28: COTTONTAIL LANE SAUGERTIES, NY 12477

TAX MAP PARCEL 32.11: NEW YORK STATE ROUTE 212 SAUGERTIES, N.Y. 12477

BOUNDARY & TOPOGRAPHIC SURVEY OF THE LANDS OF SAUGERTIES DEVELOPERS LLC

Ausfeld & Waldruff Land Surveyors LLP

323 CLINTON STREET, SCHENECTADY NY
Phone: (518) 346-1595 Fax: 518-770-1655

VINCENT P. AUSFELD P.L.S.
LICENSE #049597

WWW.awlsllp.com

GENERAL NOTES

- EXISTING CONDITIONS DATA WAS COMPILED USING A SURVEY TITLED "ATLA/NPS LAND TITLE BOUNDARY SURVEY OF THE LANDS OF SAUGERTIES DEVELOPERS LLC" BY AUSFELD & WALDRUFF LAND SURVEYORS, DATED OCTOBER 26, 2021.
- PRIOR TO COMMENCING ANY EXCAVATION WORK, THE CONTRACTOR SHALL CONTACT U.F.P.O. (1-800-962-7962) AND THE PROPER LOCAL AUTHORITIES OR RESPECTIVE UTILITY COMPANY HAVING JURISDICTION TO CONFIRM THE LOCATION OF ALL EXISTING UTILITIES BEFORE COMMENCING WORK. ANY COSTS INCURRED BY THE CONTRACTOR DUE TO FAILURE TO CONTACT THE PROPER AUTHORITIES SHALL BECOME THE RESPONSIBILITY OF THE CONTRACTOR.
- 3. PRIOR TO DEMOLITION, THE CONTRACTOR SHALL RETAIN THE SERVICES OF A UTILITY LOCATING SERVICE IN ACCORDANCE WITH SPECIFICATION, THAT SHALL BE RESPONSIBLE FOR LOCATING AND DOCUMENTING ALL UNDERGROUND UTILITIES.
- 4. THE LOCATIONS OF ALL UNDERGROUND UTILITIES SHOWN ON THESE PLANS ARE DIAGRAMMATIC ONLY. CONTRACTOR SHALL COORDINATE LOCATION OF ALL UTILITIES (LINES, DUCTS, CONDUITS, SLEEVES, FOOTINGS, ETC.) WITH LOCATIONS OF PROPOSED LANDSCAPE ELEMENTS (WALLS, FENCE, FOOTINGS, TREE ROOTBALLS, PROPOSED LIGHTING FOOTINGS, ETC.). EXCAVATION REQUIRED WITHIN PROXIMITY OF UTILITY LINES SHALL BE DONE BY HAND. ANY
- 5. THE GENERAL CONTRACTOR SHALL VERIFY ALL SITE CONDITIONS IN THE FIELD AND REPORT ANY DISCREPANCY BETWEEN THE PLANS AND THE ACTUAL FIELD CONDITIONS TO THE OWNER.

DAMAGE AND INCURRED COSTS DUE TO FAILURE OF THE CONTRACTOR TO CONTACT THE PROPER AUTHORITIES SHALL BE BORNE BY THE CONTRACTOR.

- 6. LIMIT OF WORK LINE IS NOTED ON DRAWINGS. CONTRACTOR IS RESPONSIBLE FOR ALL DAMAGE DUE TO OPERATIONS INSIDE AND OUTSIDE OF THE LIMITS OF WORK LINE. ANY AREAS OUTSIDE THE LIMIT OF WORK THAT ARE DISTURBED SHALL BE RESTORED TO ITS ORIGINAL CONDITION AT NO ADDITIONAL COST TO THE OWNER. CONTRACTOR SHALL MEET LINE AND GRADE OF EXISTING CONDITIONS AT LIMIT OF WORK LINE. IF NO LIMIT OF WORK IS SHOWN, THE PROPERTY LINE SHALL BE THE LIMIT OF WORK.
- 7. THE CONTRACTOR SHALL ESTABLISH PERMANENT BENCH MARKS. MAINTAIN ALL ESTABLISHED BOUNDS AND BENCH MARKS AND REPLACE ANY WHICH ARE DESTROYED OR DISTURBED.
- 8. CONTRACTOR SHALL EMPLOY SPECIAL CARE IN SCHEDULING CONSTRUCTION SO AS TO MAINTAIN EXISTING VEHICULAR TRAFFIC PATTERNS, AND MINIMIZE DISRUPTION TO SURROUNDING PEDESTRIAN TRAFFIC. CONTRACTOR SHALL EMPLOY SPECIAL CARE TO PROTECT SAFETY OF PEDESTRIANS INSIDE AND OUTSIDE OF THE LIMIT OF WORK LINE.
- 9. IT IS THE CONTRACTOR'S RESPONSIBILITY TO ENSURE ALL REQUIRED PERMITS FROM ALL JURISDICTIONS AFFECTED BY THIS WORK ARE IN PLACE PRIOR TO CONSTRUCTION. FOR PERMITS ALREADY ISSUED, CONTRACTOR SHALL OBTAIN COPIES OF PERMITS AND STRICTLY ADHERE TO PERMIT CONDITIONS. PERMITS THAT ARE OUTSTANDING SHALL BE SECURED BY THE CONTRACTOR AND COORDINATED WITH THE DIRECTOR'S REPRESENTATIVE.
- 10. ALL ALTERATIONS TO THESE DRAWINGS MADE IN THE FIELD DURING CONSTRUCTION SHALL BE RECORDED BY THE CONTRACTOR ON "RECORD DRAWINGS," AS SPECIFIED.
- 11. STORAGE AREAS FOR THE GENERAL CONTRACTOR'S EQUIPMENT AND MATERIALS SHALL BE LOCATED WITHIN THE LIMITS OF WORK AS SHOWN ON THE PLANS OR AS APPROVED BY THE OWNER.
- 12. SHOULD ANYTHING BE OMITTED FROM THE PLANS WHICH IS NECESSARY FOR A COMPLETE UNDERSTANDING OF THE WORK, OR SHALL ANY ERROR APPEAR IN THE VARIOUS INSTRUMENTS FURNISHED OR IN THE WORK BY OTHER CONTRACTORS AFFECTING THE WORK COVERED HEREBY, THE CONTRACTOR SHALL AND WILL PROMPTLY NOTIFY THE DIRECTOR'S REPRESENTATIVE, AND IN THE EVENT OF THE CONTRACTOR'S FAILURE TO DO SO, HE SHALL AND WILL MAKE GOOD OF ANY DAMAGE OR DEFECT IN HIS WORK CAUSED THEREBY.
- 13. CONTRACTOR SHALL MAINTAIN THE INTEGRITY OF ALL EXISTING INFRASTRUCTURE FOR THE DURATION OF CONSTRUCTION. CONTRACTOR SHALL PROTECT AND SUSTAIN IN NORMAL SERVICE ALL EXISTING UTILITIES, STRUCTURES, EQUIPMENT, ROADWAYS AND DRIVEWAYS.
- 14. THE CONTRACTOR SHALL BE RESPONSIBLE TO COORDINATE HIS EFFORTS OF DEMOLITION, REMOVALS AND OR RELOCATION WORK WITH ALL TRADES. CONSULT ALL DRAWINGS AND SPECIFICATIONS FOR ADDITIONAL COORDINATION REQUIREMENTS BEFORE COMMENCING CONSTRUCTION.
- 15. CONTRACTOR TO COMPLY WITH ALL OSHA AND OTHER STATE AND LOCAL SAFETY REQUIREMENTS DURING CONSTRUCTION.
- 16. CONTRACTOR SHALL MAINTAIN NECESSARY TRAFFIC CONTROL DEVICES, DRUMS, DELINEATORS, SIGNS, FENCES, AND BARRICADES IN ACCORDANCE WITH THE LATEST EDITION OF THE NATIONAL MUTCD WITH NYS SUPPLEMENT TO PROPERLY PROTECT WORK, EQUIPMENT, PERSONS, AND PROPERTY FROM DAMAGE. ALL DAILY TRAFFIC IN THE VICINITY OF THE SITE SHALL NOT BE IMPEDED.

SITE PREPARATION AND SITE DEMOLITION NOTES

TO THE OWNER, SHALL BE LEGALLY DISPOSED OF OFF-SITE BY THE CONTRACTOR.

- PRIOR TO CONSTRUCTION, CONTRACTOR SHALL ARRANGE PRE-CONSTRUCTION MEETING WITH DIRECTOR'S REPRESENTATIVE TO REVIEW ALL APPLICABLE PERMIT CONDITIONS, THE CONSTRUCTION PLANS AND GENERAL CONSTRUCTION SCHEDULE.
- 2. CONTRACTOR SHALL REFER TO PROJECT STORMWATER POLLUTION PREVENTION PLAN (SWPPP) PRIOR TO MOBILIZATION / CONSTRUCTION. ALL WORK SHALL BE IN ACCORDANCE WITH THE PROJECT SWPPP. ALL EROSION CONTROL MEASURES SHALL BE IN PLACE PRIOR TO ANY EARTH DISTURBING ACTIVITIES. REFER TO PROJECT PLANS, NOTES AND DETAILS.
- THE CONTRACTOR'S ATTENTION IS DIRECTED TO THE GENERAL NOTES, UTILITY NOTES, SPECIFICATIONS, AND UTILITY LOCATING SERVICE REQUIREMENTS. NO WORK SHALL COMMENCE UNTIL UNDERGROUND UTILITIES WITHIN THE SITE HAVE BEEN IDENTIFIED AND LOCATED.
- 4. ALL REFUSE. DEBRIS AND MISCELLANEOUS ITEMS TO BE REMOVED. THAT ARE NOT TO BE STOCKPILED FOR LATER USE ON THE PROJECT OR DELIVERED
- 5. CONTRACTOR SHALL STRIP AND STOCKPILE EXISTING TOPSOIL TO FULL DEPTH WITHIN LIMIT OF GRADING BEFORE COMMENCING EXCAVATION AND
- GRADING OPERATIONS. TOPSOIL SHALL NOT BE REMOVED FROM THE SITE, UNLESS APPROVED BY THE DIRECTOR'S REPRESENTATIVE.
- 6. THE CONTRACTOR SHALL COORDINATE ALL ADJUSTMENT OR ABANDONMENT OF UTILITIES WITH THE RESPECTIVE UTILITY COMPANY AND PAY ALL ASSOCIATED COSTS.
- 7. CONTRACTOR SHALL ABIDE BY ALL PERMITS THAT MAY BE REQUIRED FROM ALL JURISDICTIONS AFFECTED BY THIS WORK.
- 8. CONTRACTOR SHALL PROTECT AND SUSTAIN IN NORMAL SERVICE ALL EXISTING UTILITIES, STRUCTURES, EQUIPMENT, ROADWAYS AND DRIVEWAYS.
- BEFORE ANY CLEARING IS DONE. THE CONTRACTOR SHALL ARRANGE A CONFERENCE ON THE SITE WITH THE LANDSCAPE ARCHITECT TO IDENTIFY TREES WHICH ARE TO BE PROTECTED OR REMOVED. DO NO CLEARING WITHOUT A CLEAR UNDERSTANDING OF EXISTING CONDITIONS TO BE PRESERVED.
- 10. AT ALL LOCATIONS WHERE EXISTING PAVEMENT ABUTS NEW CONSTRUCTION, THE EDGE OF THE EXISTING PAVEMENT SHALL BE SAW CUT TO A CLEAN, SMOOTH AND SHARP EDGE AND PROTECTED UNTIL ABUTTING MATERIALS ARE INSTALLED.
- 11. IT IS THE RESPONSIBILITY OF THE CONTRACTOR TO COORDINATE WITH THE DIRECTOR'S REPRESENTATIVE ON ALL MATERIALS TO BE REMOVED AND RECYCLED/DISPOSED OF OFF SITE. ALL HANDLING OF MATERIALS TO BE REMOVED, RECYCLED, OR DISPOSED OF MUST BE DONE SO IN A SAFE, LEGAL MANNER, IN ACCORDANCE WITH ALL LOCAL, COUNTY, STATE, FEDERAL AND ANY OTHER APPLICABLE REGULATIONS.
- 12. ALL ITEMS REQUIRING REMOVAL SHALL BE REMOVED TO FULL DEPTH, INCLUDING BASE MATERIAL AND FOOTINGS OR FOUNDATIONS, UNLESS OTHERWISE NOTED.
- 13. EXISTING ITEMS INDICATED TO BE SALVAGED OR STOCKPILED SHALL BE CAREFULLY REMOVED AND STORED AS DIRECTED BY THE DIRECTOR'S REPRESENTATIVE.
- 14. TREE, SHRUB AND VEGETATION REMOVAL SHALL INCLUDE THE FELLING, CUTTING, GRUBBING OUT OF ENTIRE ROOT SYSTEM AND SATISFACTORY OFF-SITE DISPOSAL OF ALL TREES, SHRUBS, STUMPS, VEGETATIVE AND EXTRANEOUS DEBRIS PRODUCED THROUGH THE REMOVAL OPERATIONS. PITS/HOLES REMAINING AFTER GRUBBING OPERATIONS SHALL BE BACKFILLED AND COMPACTED AS SPECIFIED.
- 15. THE CONTRACTOR IS RESPONSIBLE FOR VERIFYING EXISTING CONDITIONS AND PERFORMING ALL SITE DEMOLITION AND REMOVALS REQUIRED TO FACILITATE PROPOSED CONSTRUCTION.
- 16. FIELD VERIFY EXISTING UTILITIES AND RESPECTIVE CONNECTIONS AND REPORT FINDINGS TO DIRECTOR'S REPRESENTATIVE, UPON AUTHORIZATION, REMOVE AND DISPOSE FENCE AND UTILITIES AND ABANDON CONNECTION IN ACCORDANCE WITH CODES AND REQUIREMENTS OF AUTHORITIES HAVING JURISDICTION, IF UTILITIES MUST REMAIN IN SERVICE, PROTECT AGAINST DAMAGE AND MAINTAIN INTEGRITY OF SYSTEM.

LAYOUT NOTES:

- ALL LINE AND GRADE INFORMATION SHALL BE LAID OUT BY A NEW YORK STATE LICENSED SURVEYOR ENGAGED BY THE CONTRACTOR.
- 2. ALL NEW WORK SHALL BE STAKED OUT PRIOR TO CONSTRUCTION. THE DIRECTOR'S REPRESENTATIVE SHALL BE NOTIFIED OF ANY DISCREPANCIES. FIELD ADJUSTMENTS MUST BE APPROVED BY THE DIRECTOR'S REPRESENTATIVE PRIOR TO CONSTRUCTION.
- 3. ALL LINES AND DIMENSIONS ARE PARALLEL OR PERPENDICULAR TO THE LINES FROM WHICH THEY ARE MEASURED UNLESS OTHERWISE NOTED.
- 4. DIMENSIONS TO CURBS ARE FROM FACE OR BOTTOM OF CURB TO FACE OR BOTTOM OF CURB.
- 5. FIELD ADJUSTMENTS MUST BE APPROVED BY THE DIRECTOR'S REPRESENTATIVE AND IF NECESSARY APPROPRIATE MUNICIPAL OFFICIALS.
- 6. ALL PROPOSED WALKS, PAVEMENTS, LIGHTS AND SITE IMPROVEMENTS SHALL BE STAKED IN THE FIELD FOR APPROVAL BY THE DIRECTOR'S REPRESENTATIVE PRIOR TO CONSTRUCTION.
- CONTRACTOR SHALL COORDINATE LOCATION OF ALL UTILITIES (LINES, DUCTS, CONDUITS, SLEEVES, FOOTINGS, ETC.) WITH LOCATIONS OF PROPOSED LANDSCAPE ELEMENTS (WALLS, FENCE, FOOTINGS, TREE ROOTBALLS, PROPOSED LIGHTING FOOTINGS, ETC.). CONTRACTOR SHALL REPORT ANY DISCREPANCIES TO DIRECTOR'S REPRESENTATIVE PRIOR TO CONTINUING WORK.
- ALL EXISTING UTILITIES ARE SHOWN IN THEIR RELATIVE POSITION. CONTRACTOR IS RESPONSIBLE FOR VERIFYING THE VERTICAL & HORIZONTAL

EROSION AND SEDIMENT CONTROL NOTES

- 1. THE CONTRACTOR'S ATTENTION IS DIRECTED TO THE REQUIREMENTS OF THE NEW YORK STATE DEPARTMENT OF ENVIRONMENTAL CONSERVATION (NYSDEC) STATE POLLUTANT DISCHARGE ELIMINATION SYSTEM SPDES GENERAL PERMIT FOR STORMWATER DISCHARGES FROM CONSTRUCTION ACTIVITY GP-0-20-001, THE STORMWATER POLLUTION PREVENTION PLAN (SWPPP) DEVELOPED FOR THIS PROJECT IS IN ACCORDANCE WITH THE GENERAL PERMIT FOR STORMWATER DISCHARGES FROM CONSTRUCTION ACTIVITY.
- 2. ALL CONSTRUCTION SHALL BE IN STRICT ACCORDANCE WITH THE STORMWATER POLLUTION PREVENTION PLAN (SWPPP), AND GENERAL CONSTRUCTION SEQUENCING. PRIOR TO CONSTRUCTION, THE CONTRACTOR SHALL REVIEW THE PROJECT SWPPP FOR SPECIFIC REQUIREMENTS REGARDING EROSION AND SEDIMENT CONTROL AND STORMWATER MANAGEMENT. A COPY OF THE SWPPP MUST BE MAINTAINED ON THE PROJECT SITE IN AN ACCESSIBLE LOCATION AT ALL TIMES DURING CONSTRUCTION.
- 3. PRIOR TO ANY SITE WORK, ALL CONTRACTORS AND SUBCONTRACTORS RESPONSIBLE FOR CONSTRUCTION, REPAIR, AND MAINTENANCE OF ANY EROSION AND SEDIMENT CONTROLS OR STORMWATER DEVICES MUST SIGN/CERTIFY THE SWPPP AND IDENTIFY A 'TRAINED CONTRACTOR'.
- 4. PRIOR TO BEGINNING EARTHWORK ACTIVITY, THE CONTRACTOR SHALL SUBMIT A MOBILIZATION PLAN SHOWING PROPOSED STOCKPILE AND STAGING AREAS, HAUL/ACCESS ROADS, FIELD OFFICES AND EQUIPMENT STORAGE AREAS, AND A SCHEDULE DETAILING THE STAGING OF CONSTRUCTION TO THE QUALIFIED INSPECTOR (SWPPP INSPECTOR) AND DIRECTOR'S REPRESENTATIVE FOR APPROVAL.
- 5. THE CONTRACTOR SHALL NOT DISTURB MORE THAN (5) ACRES AT ANY ONE TIME WITHOUT PRIOR WRITTEN AUTHORIZATION FROM NYSDEC. ALL DISTURBED AREAS THAT DO NOT MEET THE DEFINITION OF "FINAL STABILIZATION" AS LISTED IN THE NYSDEC SPDES GENERAL PERMIT FOR STORMWATER DISCHARGES MUST BE INCLUDED WHEN CALCULATING THE TOTAL AREA DISTURBED AT ANY ONE TIME. FINAL STABILIZATION CAN INCLUDE CRUSHED STONE, PAVEMENT, OR SEEDED LAWN WITH A MINIMUM DENSITY OF 80% COVERAGE.
- 6. EROSION CONTROL DEVICES SHALL BE INSPECTED DAILY AND MAINTAINED TO ENSURE SATISFACTORY PERFORMANCE AND COMPLIANCE WITH THE SWPPP.
- 7. IT IS THE CONTRACTOR'S RESPONSIBILITY TO CHECK THE SWPPP FOR INSPECTION REPORTS, AND IMMEDIATELY MAKE REPAIRS AND CORRECTIONS NOTED. REMEDIATION WORK THAT IS REQUIRED AS A RESULT OF FAILING TO MAKE REPAIRS SHALL BE PERFORMED BY THE CONTRACTOR AT NO ADDITIONAL COST TO THE OWNER.
- 8. ANY CHANGES TO THE SWPPP PROPOSED BY THE CONTRACTOR MUST BE APPROVED BY THE QUALIFIED INSPECTOR AND INCORPORATED INTO THE SWPPP PRIOR TO IMPLEMENTATION.
- REPRESENTATIVE. IF THE CONTRACTOR PROPOSES A REVISED STAGING, SEQUENCING AND/OR MOBILIZATION PLAN, A MODIFIED PLAN MUST BE SUBMITTED TO THE QUALIFIED INSPECTOR FOR APPROVAL.

9. ANY DEVIATIONS FROM OR CONSTRUCTION CONFLICTS WITH THE PROJECT SWPPP SHALL BE IMMEDIATELY REPORTED TO THE DIRECTOR'S

- 10. THE CONTRACTOR SHALL INITIATE TEMPORARY AND PERMANENT STABILIZATION MEASURES AS SOON AS PRACTICABLE IN ACCORDANCE WITH THE
- 11. ALL DISTURBED AREAS SHALL BE STABILIZED IN ACCORDANCE WITH THE PLANS AND PROJECT SWPPP. IN ADDITION TO WHAT IS SHOWN ON PLANS, ANY SLOPES GREATER THAN 3:1 DISTURBED AS PART OF CONSTRUCTION SHALL BE STABILIZED IN ACCORDANCE WITH PROJECT DETAILS AND SWPPP.
- 12. EROSION AND SEDIMENT CONTROL PROTECTIONS SHOWN ON THE PLANS REPRESENT THE MINIMUM MEASURES NECESSARY. ADDITIONAL MEASURES AND DEVICES MAY BE NEEDED DUE TO SITE SPECIFIC CONDITIONS OR CHANGING CONDITIONS DUE TO CONSTRUCTION, IN ORDER TO MAINTAIN COMPLIANCE WITH THE SWPPP AND GENERAL PERMIT, AND SHALL BE PROVIDED BY THE CONTRACTOR AT NO ADDITIONAL COST TO THE OWNER.
- 13. EROSION AND SEDIMENT CONTROL PRACTICES SHALL BE MAINTAINED IN PLACE UNTIL CONSTRUCTION IS COMPLETED AND THE AREA IS STABILIZED AND APPROVED BY THE QUALIFIED INSPECTOR.

TYPICAL EROSION AND SEDIMENT CONTROL SEQUENCING

CONSTRUCTION ASSOCIATED WITH EROSION AND SEDIMENT CONTROL SHALL TYPICALLY PROCEED IN THE FOLLOWING SEQUENCE. ANY DEVIATIONS OR ADJUSTMENTS TO THE TYPICAL SEQUENCING SHALL BE APPROVED BY THE QUALIFIED INSPECTOR. ALL EROSION AND SEDIMENT CONTROL PRACTICES SHALL BE IMPLEMENTED IN STRICT ACCORDANCE WITH THE PROJECT STORMWATER POLLUTION PREVENTION PLAN, AND CONTRACT DOCUMENTS. PRE-CONSTRUCTION AND SITE PREPARATION

PRE CONSTRUCTION MEETING - PROTOCOL MAY BE MODIFIED BY DESIGNATED QUALIFIED INSPECTOR.

- 2. DEFINE INSPECTION SCHEDULE, REVIEW STORMWATER POLLUTION PREVENTION PLAN.
- 3. DEFINE LIMITS OF DISTURBANCE AND CLEARING LIMITS. 4. INSTALL TREE PROTECTION, AND WETLAND PROTECTION FENCE IF REQUIRED.
- 5. INSTALL STABILIZED CONSTRUCTION ACCESS AND INITIAL STAGING AREAS.
- 6. INSTALL PERIMETER EROSION CONTROL INCLUDING SILT FENCE, FILTER SOCKS, ETC.
- 7. CLEAR AND GRUB EXISTING VEGETATION.

TEMPORARY RUNOFF AND DRAINAGE CONTROL 8. TEMPORARILY STABILIZE CLEARED AREAS THAT WILL NOT BE DISTURBED WITHIN 14 DAYS

- 9. INSTALL ADDITIONAL PERIMETER EROSION CONTROL IN CLEARED AREAS AS NEEDED.
- 10. INSTALL INLET PROTECTION

EARTHWORK AND SITE CONSTRUCTION 11. STRIP & STOCKPILE TOPSOIL.

- 12. INSTALL INFRASTRUCTURE, INCLUDING CATCH BASINS WITH INLET PROTECTION, PIPING, AND PERMANENT DRAINAGE STRUCTURES.
- 13. PERFORM ROUGH GRADING.
- TEMPORARY STABILIZATION OF WORK AREA
- 14. STABILIZE ALL BARE SOIL AREAS AS SOON AS PRACTICAL AND IN ACCORDANCE WITH THE SWPPP.
- INSPECT ALL PERIMETER EROSION CONTROL AND REPAIR AS NEEDED AND/OR DIRECTED. 16. INSTALL/REPAIR ALL INLET / OUTLET PROTECTION, AND STRUCTURAL STABILIZATION SUCH AS EROSION CONTROL BLANKETS, RIP RAP, AND CHECKDAMS.

- PERFORM SOIL RESTORATION, DECOMPACTION AND FINISHED GRADING.
- 19. INSTALL SOD OR SEED, MULCH ALL GRASSED AREAS AND STABILIZE SLOPES IN ACCORDANCE WITH THE SWPPP AND CONTRACT DOCUMENTS.
- 20. INSTALL PROPOSED PLANT MATERIALS.
- 21. RECEIVE CERTIFICATION OF FINAL STABILIZATION FROM QUALIFIED INSPECTOR.

17. REMOVE SEDIMENT FROM TRAPPING DEVICES IN ACCORDANCE WITH THE SWPPP.

- 22. CLEAN ALL STORMWATER SYSTEMS OF SEDIMENT, TRASH, AND DEBRIS. 23. REMOVE TEMPORARY EROSION AND SEDIMENT CONTROL MEASURES ONLY WHEN WORK AREAS ARE APPROVED AS STABILIZED BY THE QUALIFIED
- INSPECTOR.

PLANTING NOTES:

- 1. ALL NEW PLANT MATERIAL SHALL CONFORM TO THE MINIMAL GUIDELINES ESTABLISHED BY THE AMERICAN STANDARD FOR NURSERY STOCK PUBLISHED BY THE AMERICAN ASSOCIATION OF NURSERYMEN, INC. ALL NEW MATERIAL FOR THE PROJECT SHALL BE OF SPECIMEN QUALITY UNLESS APPROVED OTHERWISE BY DIRECTOR'S REPRESENTATIVE.
- 2. ALL CONTAINER GROWN PLANTS SHALL BE PREMIUM QUALITY AND APPEAR 'FULL' IN HEIGHT AND WIDTH WITHIN THE POT. PLANTS DEEMED SUBSTANDARD IN SIZE SHALL BE REJECTED.
- 3. ALL NEW PLANTS TO BE BALLED AND BURLAPPED OR CONTAINER GROWN UNLESS OTHERWISE NOTED ON PLANT LIST.
- 4. THE CONTRACTOR SHALL SUPPLY ALL NEW PLANT MATERIAL IN QUANTITIES SUFFICIENT TO COMPLETE THE PLANTING SHOWN ON THE DRAWINGS.
- 5. IN GENERAL, PLANT SPECIES SUBSTITUTIONS WILL NOT BE ACCEPTED. IF SPECIFIED MATERIAL IS NOT OBTAINABLE, CONTRACTOR SHALL SUBMIT PROOF OF NON-AVAILABILITY TO LANDSCAPE ARCHITECT ALONG WITH PROPOSED SUBSTITUTION. ANY PROPOSED SUBSTITUTIONS OF PLANT SPECIES SHALL BE MADE WITH PLANTS OF EQUIVALENT OVERALL FORM, HEIGHT, SIZE, BRANCHING HABIT, FLOWER, LEAF, COLOR, FRUIT AND CULTURE, AND ONLY AFTER WRITTEN APPROVAL OF THE LANDSCAPE ARCHITECT.
- 6. CONTRACTOR SHALL LOCATE AND VERIFY ALL EXISTING UTILITY LINES PRIOR TO PLANTING AND SHALL REPORT ANY CONFLICTS TO THE DIRECTOR'S REPRESENTATIVE.
- 7. NEW SHRUBS AND GROUND COVER SHALL BEAR THE SAME RELATIONSHIP TO GRADE AS IT BORE TO PREVIOUS GRADE. NO TREES SHALL BE PLANTED BEFORE ACCEPTANCE OF ROUGH GRADING.
- 8. ALL PLANT BEDS TO RECEIVE THREE INCHES (3") OF BARK MULCH UNLESS OTHERWISE SPECIFIED.
- 9. ALL AREAS PROPOSED FOR LAWN SEEDING SHALL RECEIVE A MINIMUM OF 6" OF SUITABLE TOPSOIL PRIOR TO SEEDING. ALL DISTURBED AREAS NOT SCHEDULED FOR PROPOSED WORK SHALL RECEIVE FOUR INCHES (4") OF SUITABLE TOPSOIL PRIOR TO SEEDING.
- 10. PLANTS SHALL BE DELIVERED ONLY AS THEY CAN BE INSTALLED IN REASONABLE TIME. ALL PLANTS ARE SUBJECT TO INSPECTION AT DELIVERY BY THE LANDSCAPE ARCHITECT/DIRECTOR'S REPRESENTATIVE.
- 11. IF DISCREPANCIES EXIST BETWEEN THE NUMBER OF PLANTS DRAWN ON THE PLANTING PLAN AND THE NUMBER OF PLANTS IN THE PLANT LIST. THE PLANTING PLAN SHALL GOVERN.

12. STAKE LOCATION OF ALL PROPOSED PLANTING FOR APPROVAL BY LANDSCAPE ARCHITECT PRIOR TO THE COMMENCEMENT OF PLANTING.

GRADING NOTES

- 1. ALL PROPOSED GRADES SHALL BE SET IN THE FIELD BY A NEW YORK STATE LICENSED LAND SURVEYOR.
- 2. CONTRACTOR SHALL ESTABLISH PERMANENT SECONDARY BENCHMARKS PRIOR TO THE START OF CONSTRUCTION, ALL SECONDARY BENCHMARKS SHALL BE SO LOCATED THAT THEY WILL NOT BE DISTURBED BY CONSTRUCTION.
- 3. PITCH EVENLY BETWEEN SPOT GRADES. ALL PAVED AREAS MUST PITCH TO DRAIN AT A MINIMUM SLOPE OF ONE-EIGHTH INCH (1/8") PER FOOT.
- 4. MAXIMUM CROSSPITCH OF ALL SIDEWALKS IS 2%. RAMPS SHALL NOT EXCEED 1 IN 12 OR 30' IN LENGTH. ANY DISCREPANCIES NOT ALLOWING THIS TO OCCUR SHALL BE REPORTED TO THE DIRECTOR'S REPRESENTATIVE PRIOR TO CONTINUING WORK.
- 5. SITE PAVEMENT SHALL MEET ALL BUILDING DOOR THRESHOLDS FLUSH AND IN ACCORDANCE WITH ADA GUIDELINES.
- 6. ALL PROPOSED TOP OF VERTICAL CURB ELEVATIONS ARE SIX INCHES (6") ABOVE BOTTOM OF CURB UNLESS SHOWN OTHERWISE.
- 7. WHERE NEW PAVING MEETS EXISTING PAVING, NEW PAVING SHALL MEET THE LINE AND GRADE OF THE EXISTING PAVING.
- 8. SET CATCH BASIN AND DROP INLET RIMS TO DRAIN SURROUNDING AREAS AND AT SAME PITCH AS SLOPING PAVEMENT. IF STRUCTURE IS SHOWN ADJACENT TO CURB, SET GRATE TIGHT TO FACE OF CURB.
- 9. EXCAVATION REQUIRED WITHIN 3 FEET OF EXISTING UTILITY LINES SHALL BE DONE BY HAND. CONTRACTOR SHALL REPAIR ANY DAMAGE TO EXISTING UTILITY LINES OR STRUCTURES INCURRED DURING CONSTRUCTION OPERATIONS AT NO ADDITIONAL COST TO OWNER.
- 10. ALL EARTHWORK SHALL BE IN ACCORDANCE WITH THE GEOTECHNICAL REPORT AND SPECIFICATIONS.
- 11. GRADE AREAS ADJACENT TO BUILDING LINES TO DRAIN AWAY FROM STRUCTURE AND PREVENT PONDING. FINISH SURFACES SHALL BE FREE FROM IRREGULAR SURFACE CHANGES.
- 12. EXCAVATION REQUIRED WITHIN DRIP LINE OF TREES DESIGNATED TO REMAIN SHALL BE DONE BY HAND. PLANT MATERIALS DAMAGED BY CONTRACTOR SHALL BE REPLACED IN KIND.
- 13. SLOPE SIDES OF EXCAVATIONS TO COMPLY WITH LOCAL CODES AND ORDINANCES HAVING JURISDICTION AND OSHA REGULATIONS. MAINTAIN SIDE SLOPES OF EXCAVATIONS IN A SAFE CONDITION UNTIL COMPLETION OF BACKFILLING.
- 14. THE GENERAL CONTRACTOR SHALL MAINTAIN OR ADJUST TO NEW FINISH GRADE AS NECESSARY ALL UTILITY AND SITE STRUCTURES SUCH AS LIGHT POLES, SIGN POLES, MAN HOLES, CATCH BASINS, HAND HOLES, WATER AND GAS GATES, HYDRANTS, ETC., FROM MAINTAINED UTILITY AND SITE SYSTEMS UNLESS OTHERWISE NOTED ON THE UTILITY DRAWINGS OR AS DIRECTED BY THE DIRECTOR'S REPRESENTATIVE.
- 15. CONTRACTOR SHALL BLEND NEW EARTHWORK SMOOTHLY INTO EXISTING, PROVIDING VERTICAL CURVES OR ROUNDINGS AT ALL TOP AND BOTTOM OF SLOPES.

2"-2 1/2" cal. B&B

2"-2 1/2" cal. B&B

2"-2 1/2" cal. B&B

6'-8' ht. B&B, MULTI-STEM

- 16. CONTRACTOR SHALL MAINTAIN THE INTEGRITY OF THE EXISTING DRAINAGE SYSTEM AT ALL TIMES. WHEN IT IS NECESSARY TO INTERRUPT THE EXISTING DRAINAGE PATTERNS AND/OR UTILITIES, PROVIDE TEMPORARY FACILITIES UNTIL WORK IS PERMANENTLY STABILIZED AND APPROVED BY DIRECTOR'S REPRESENTATIVE.
- 17. THE SIDES OF ANY NEW CUT AND/OR FILL SLOPES SHALL BE CONSTRUCTED W/ITH SLOPES NO STEEPER THAN 1 FOOT (VERTICAL) OVER 2 FOOT (HORIZONTAL).

COMMON NAME

Heritage River Birch

Red Maple

Sugar Maple

Yellow Wood

PLANT SCHEDULE

DECIDUOUS TREES

SYM. QTY. BOTANICAL NAME

Acer rubrum 'Frank's Red'

Acer saccharum 'Green Mountain

Betula nigra 'Heritage'

Cladrastis kentukea

	Cladrastis kentukea	Yellow Wood	2"-2 1/2" cal.	B&B	WOODLAND RESTORATION: NATIVE RIGHT C
	Liriodendron tulipifera	Tuliptree	2"-2 1/2" cal.	B&B	WAY WOODS MIX WITH ANNUAL RYE' OR 'NA'
	Quercus bicolor	Swamp White Oak	2"-2 1/2" cal.	B&B	STEEP SLOPE MIX WITH ANNUAL RYE' BY ERN
	Quercus palustris	Pin Oak	2"-2 1/2" cal.	B&B	SEEDS, OR APPROVED EQUAL. STORMWATER MANAGEMENT PONDS:
	Quercus rubra	Northern Red Oak	2"-2 1/2" cal.	B&B	'NATIVE STEEP SLOPE MIX WITH ANNUAL RYE
RNAME	NTAL TREES				ERNST SEEDS, OR APPROVED EQUAL.
T	Amelanchier x grandiflora 'Autumn Brilliance'	Serviceberry	6'-8' ht.	B&B, MULTI-STEM	Entro Policio, orchi Provide Lagric.
	Amelanchier x grandiflora 'Autumn Brilliance'	Serviceberry	2" cal.	B&B, TREE FORM	
	Cornus florida	Dogwood	2" cal.	B&B, TREE FORM	
	Cornus kousa chinensis 'Milky Way'	Milky Way Dogwood	2" cal.	B&B, TREE FORM	
			-	B&B, MULTISTEM	
	Cercis canadensis	Eastern Redbud	6'-8' ht.	ļ · · · · · · · · · · · · · · · · · · ·	
	Malus 'Adams'	Adams Crabapple	2" cal.	B&B	
	Prunus serrulata 'Kwanzan'	Kwanzan Cherry	2" cal.	B&B	
VERGR	EEN TREES				
	Abies balsamea	Balsam Fir	6'-8' ht.	B&B	
	'Picea glauca	White Spruce	6'-8' ht.	B&B	
	Juniperus virginiana	Eastern Red Cedar	6'-8' ht.	B&B	
	Pinus strobus	Eastern White Pine	6'-8' ht.	B&B	
	Tsuga canadensis	Hemlock	6'-8' ht.	B&B	
	10090 0011000	Tiemlook	0 0 111.	BQB	
HRUBS					
	Buddleia davidii	Butterfly Bush	3 gal.	cont.	
	Ceanothus americanus	New Jersey Tea	3 gal.	cont.	
	Clethra alnifolia 'Hummingbird'	Hummingbird Clethra	3 gal.	cont.	
	Clethra alnifolia 'Ruby Spice'	Ruby Spice Clethra	3 gal.	cont.	
	Cornus alba	Red Twig Dogwood	3 gal.	cont.	
	Fothergilla gardenii	Dwarf Fothergilla	3 gal.	cont.	
	Itea virginica 'Henry's Garnet'	Virginia Sweetspire	3 gal.	cont.	
	Hydrangea paniculata 'Little Lamb'	Little Lamb Hydrangea	3 gal.	cont.	
	Hydrangea paniculata 'Little Quickfire'	Little Quickfire Hydrangea	3 gal.	cont.	
	llex glabra 'Nordic'	Inkberry	3 gal.	cont.	
	llex verticillata 'Red Sprite'	Red Sprite Winterberry	3 gal.	cont.	
	llex verticillata 'Jim Dandy'	Jim Dandy Winterbery	3 gal.	cont.	
	Myrica pensylvanica	Northern Bayberry	3 gal.	cont.	
	Philadelphus x 'Snowbelle'	Snowbelle Mockorange	3 gal.	cont.	
	Physocarpus opulifolius 'Coppertina'	Coppertina Ninebark	3 gal.		
				cont.	
	Rhododendron 'Chronicles'	Chronicles Azalea (White)	3 gal.	cont.	
	Rhododendron 'PJM'	PJM Rhododendon	5 gal.	cont.	
	Rhododendron 'Roseum Pink'	Rhoseum Pink Rhododendon	5 gal.	cont.	
	Rhododendron 'Scintillation'	Scintillation Rhododendon	5 gal.	cont.	
	Viburnum plicatum tomentosum	Double file Viburnum	5 gal.	cont.	
	Viburnum trilobum 'Bailey's Compact'	Compact Cranberrybush Viburnum	3 gal.	cont.	
	Viburnum carlesii 'Compactum'	Compact Koreanspice Viburnum	3 gal.	cont.	
FRENN	IALS / GRASSES / GROUNDCOVERS / HERB	RACEOUS			
	Anemone hupehensis 'September Charm'	September Charm Anemone	1 aal		
	<u>'</u>	'	1 gal.	cont.	
	Arctostaphylos uva-ursi	Bearberry	1 gal.	cont	
	Aster novae-angliae	New England Aster	1 gal.	cont.	
	Astilbe chinensis 'Vision in White'	Visons in White Astilbe	1 gal.	cont.	
	Calamagrostis 'Karl Foerster'	Feather Reed Grass	1 gal.	cont.	
	Carex vulpinoidea	Fox Sedge	1 gal.	cont.	
	Chasmanthium latifolium	Northern Sea Oats	1 gal.	cont.	
	Chelone obliqua	Pink Turtlehead	1 gal.	cont.	
	Dennstaedia punctiloba	Hay-scented fern	1 gal.	cont.	
	Dicentra spectabilis	Common Bleeding Heart	1 gal.	cont.	
	Echinacea purpurea 'Magnus'	Purple Coneflower	1 gal.	cont.	
	Filix-femina	lady Fern	1 gal.	cont.	
	Hemerocallis	Daylilies	1 gal.	cont.	
	Hosta 'Gold Standard'	Gold Standard Hosta	1 gal.	cont.	
-	Lobelia cardinalis	Cardinal Flower	1 gal.	cont.	
	Monarda didyma	Beebalm	1 gal.		
	<u> </u>			cont.	
	Osmunda cinnamomea	Cinnamon Fern	1 gal.	cont.	
	Osmunda regalis	Royal Fern	1 gal.	cont.	
	Panicum virgatum 'Shenandoah'	Red Switch Grass	1 gal.	cont.	
	Rudbeckia fulgida 'Goldsturm'	Black-Eyed Susan	1 gal.	cont.	
		Spring Symphony Foam Flower	1 gal.	cont.	
	Tiarella 'Spring Symphony'	Lowbush Blueberry			

SEED MIXES: REMARKS/SPACING LAWN - 'COMMERCIAL CONSERVATION SEED MIX' AND 'CONSERVATION SHADE MIX' BY ERNST SEEDS, OR SIMILAR BLEND OF PERENNIAL RYE. FESCUES, KENTUCKY BLUEGRASS AND ANNUAL WOODLAND RESTORATION: NATIVE RIGHT OF /AY WOODS MIX WITH ANNUAL RYE' OR 'NATIVE STEEP SLOPE MIX WITH ANNUAL RYE' BY ERNST SEEDS, OR APPROVED EQUAL.

Surveyor: Ausfeld & Waldruff 323 Clinton Street Schenectady, NY 12305

Project Title:

Terramor Catskills

NY ROUTE 212 Saugerties, NY 12477

ISSUED FOR:

SITE PLAN APPLICATION

BAS Ch'k'd:

07/01/2022 Scale:

People. Purpose. Place

p: 518-587-8100

£518-587-0180

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40 Long Alley

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550 N 31st Street

Billings, MT 59101

Civil Engineer:

C.T. Male Associates

50 Century Hill Drive

Latham, NY 12110

Architect:

DGC Architects

Ellsworth, ME 04605

Traffic Engineer

Albany, NY 12205

80 Wolf Road, Suite 300

40 Church Street, Studio A

Prepared for:

NY 12866

Saratoga Springs

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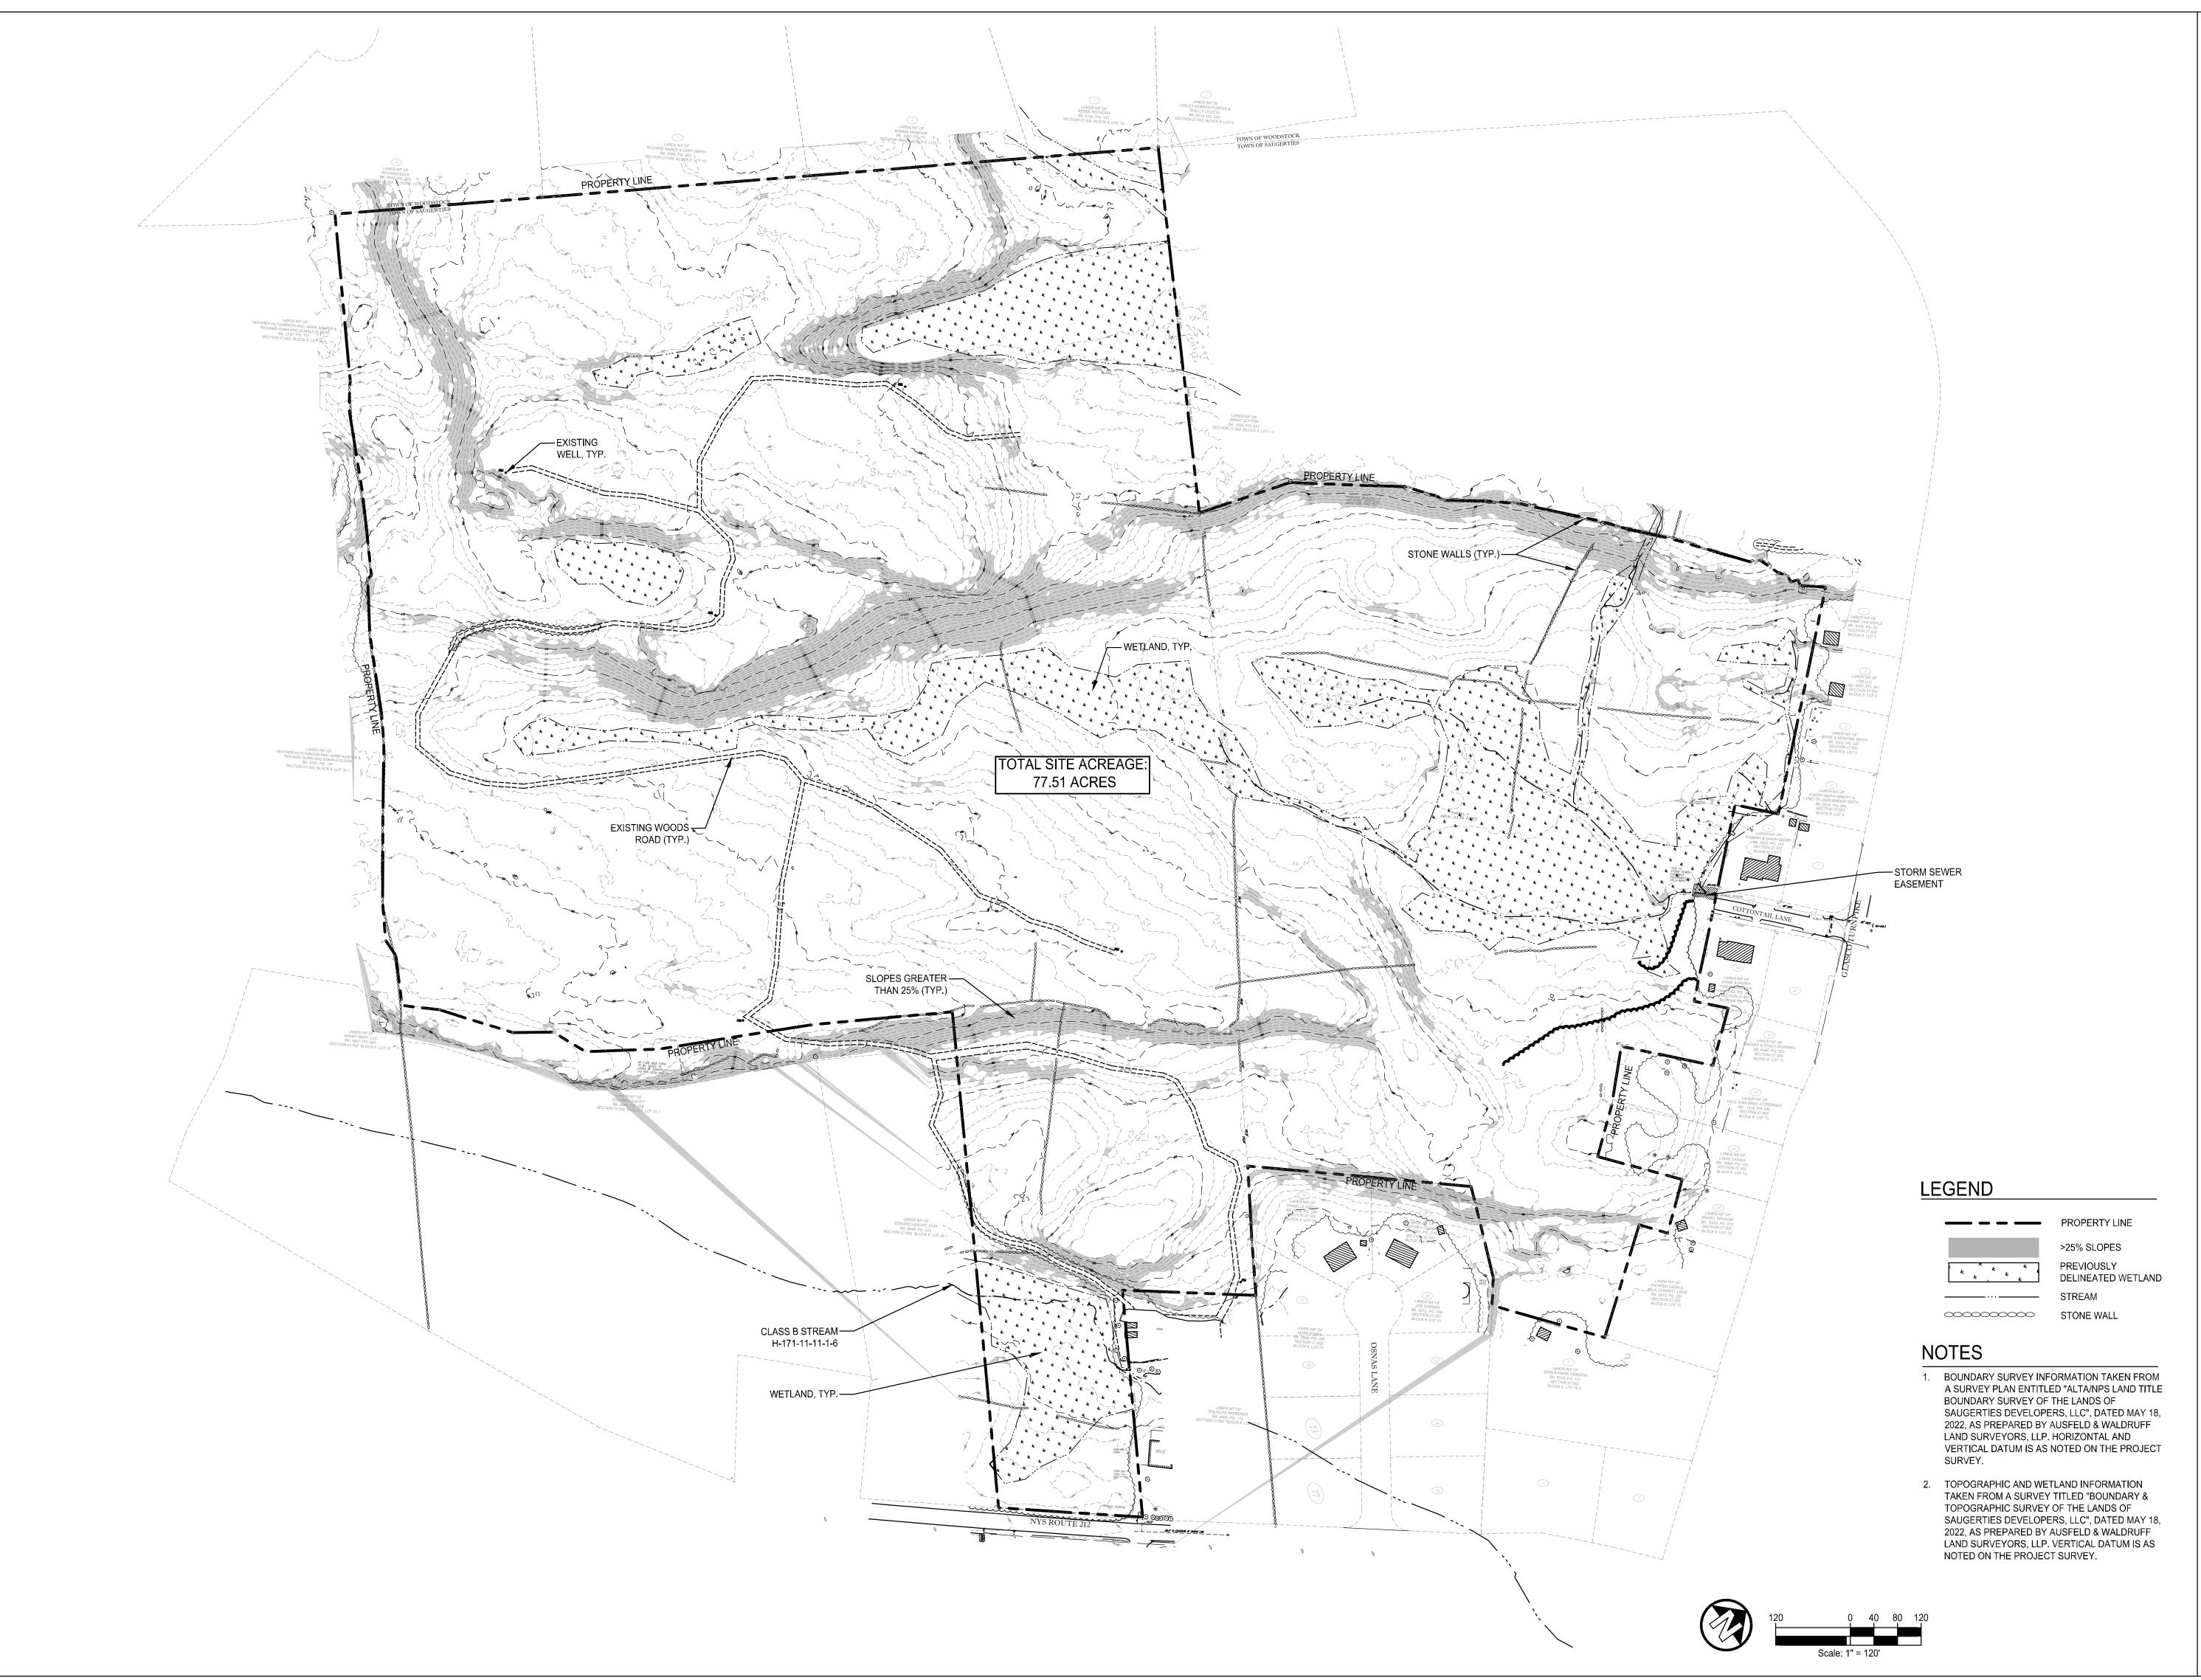
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NY 12866 www.thelagroup.com

People. Purpose. Place.

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Prepared for:

TERRAMOR.

550 N 31st Street Billings, MT 59101

Civil Engineer: C.T. Male Associates 50 Century Hill Drive Latham, NY 12110

Architect:

DGC Architects

40 Church Street, Studio A
Ellsworth, ME 04605

Traffic Engineer: GPI 80 Wolf Road, Suite 300, Albany, NY 12205

Surveyor: Ausfeld & Waldruff 323 Clinton Street Schenectady, NY 12305

Project Title:

Terramor Catskills

NY ROUTE 212 Saugerties, NY 12477

ISSUED FOR: SITE PLAN APPLICATION

Project No.:			2021096
Design:			BAS
Drawn:	BAS	Ch'k'd:	BAS
Date:	7/1/2022	Scale:	1"=120'

ev: Description: Date:


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Existing Conditions

Drawing No.

L-1.0



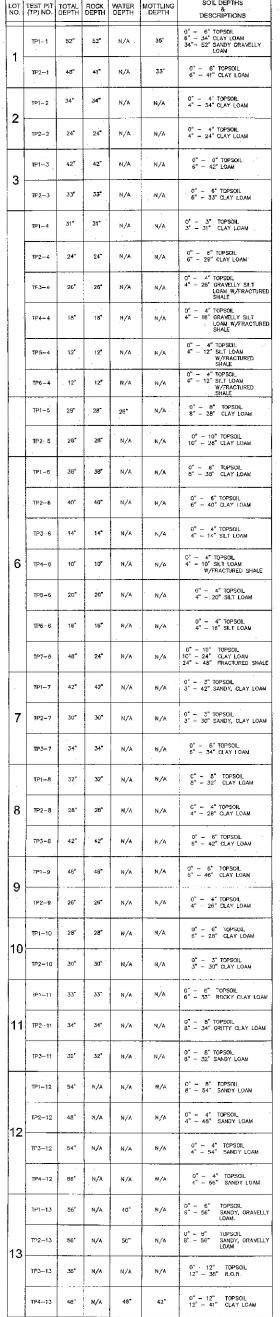

DEEP TEST RESULTS - 02/16/06, 02/22/06, 06/06/06, 07/11/06

PROPERTY LINE TEST PIT PERCOLATION TEST >25% SLOPES

PREVIOUSLY DELINEATED WETLAND

STONE WALL

NOTES

1. SOILS INFORMATION DATA FROM A PLAN TITLED "SEWAGE DISPOSAL SYSTEM TABLES," SOUTH PEAK SUBDIVISION, DATED MARCH 21, 2007, PREPARED BY ERDMAN ANTHONY.

					(C)	SOIL DEPTHS
NO.	TEST.PIT (TP) NO.	TOTAL DEPTH	ROCK DEPTH	WATER DEPTH	MOTTLING DEPTH	DESCRIPTIONS
	TP1-14	24*	24"	N/A	N/A	. 0° - 12° TOPSOIL 12° - 24° CLAY LOAM
14	TP2-14	28"	26"	N/A	N/A	0" - 28" CLAY LOAM
	TP3-14	30"	30°	24"	° N∕A	0" - 6" TOPSOIL 6" - 30" CLAY LOAM
	TP1-15	.36"	N/A	36	24"	0" - 6" TOPSOIL 6" - 24" CLAY LOAN 24" - 36" MOTTLED CL
15	TP2-15	24"	24"	N/A	N/A	0" - 5" TOPSOIL 6" - 24" CLAY LOAM
	TP315	30"	30"	24	N/A	0" - 6" TOPSOIL 6" - 30" CLAY, I GAM
4.0	TP1-15	30"	30*	H/A	N/A	0" - 6" TOPSOIL 6" - 30" CLAY LOAM
16	TP2-16	24"	24"	N/A	N/A	0" - 3" TOPSOIL 3" - 24" CLAY LOAM
47	TP1-17	24"	24"	N/A	N/A	0" - 3" TOPSOIL 3" - 24" CLAY LOAM
17	TP2-17	24"	24	N/A	N/A	0" 4" TOPSOII 4" 24" CLAY LOAM
18	TP1 18	30"	30"	N/A	N/A	0"- 1" TOPSOIL 4"- 30" GRITTY CLAY U
10	TP2-18	24"	24"	N/A	N/A	0"- 4" TOPSOIL 4"- 24" CLAY LOAM
	TP1=19	24"	24"	N/A	N/A	O" 4" TOPSOIL 4"- 24" CLAY LOAM
40	TP219	35"	35"	N/A	N/A	0"- 5" TOPSOIL 5"- 35" CLAY.LOAM
19	TP3=19	24"	N/A	36"	24 ⁿ	0" - 6" TOPSOIL 6" - 24" CLAY LOAM 24" - 36" MOTTLED CL
	TP4-19	24"	24"	N/A	N/A	O" — 6" TOPSOIL 6" — 24" CLAY LOAM
20	7P1−20	48"	48"	36"	24"	O" 8" TOPSOIL 8"- 36" CLAY LOAM
20	TP2-20	38"	38"	N/A	() () () () () ()	0"- 8" TOPSOIL 6"- 36" CLAY LOAM
	TP1-21	48"	48"	N/A	N/A	0"- 12" TOPSOE 12"- 48" GRITTY, CLAY I
21	TP2- 21	30"	30"	N/A	N/A	.0"- 12" TOPSOIL 12"- 30" :0AM
	ĭP3−21	42"	42"	N/A	N/A	0"- 12" TOPSON 12"- 42" GRITTY CLAY LO
	TP1-22	34"	34"	N/A	N/A	0"- 12" TOPSOIL 12"- 42" GRITTY CLAY i.i
22	TP2-22	72"	72"	N/A] 33"	0"- 12" TOPSOE 12"- 33" LOAM 33"- 72" MOTTLED CLAY
	TP3-22	72"	72"	N/A	3 33"	0"- 12" TOPSOIL 12"- 72" LOAM
	1P1−23	27"	74"	N/A	o∛ N/A	0"- 12" TOPSOIL 12"- 27" CLAY LOAM W/PEBBLES * TO MARDPAN
22	TP2-23	30"	30"	N/A	N/A	0" 12" TOPSOIL 12" 30" CLAY LOAM
23	TP3-23	24"	24"	N/A	N/A	O"- 6" TOPSCHL 6"- 24" BONEY, SILT LO
	TP4-23	32°	32"	N/A	N/A	0" 6" TOPSOIL 6" 32" SILT LOAM
	TP1-24	32"	32"	26"	N/A	0" 12" TOPSOIL 12"- 32" CLAY LOAM
24	TP2-24	4B"	48"	26"		0*- 12" TOPSOIL 12"- 48" GRITTY CLAY L
	TP3-24	60"	60"	41"	N/A	0"- 12" TOPSOL 12"- 48" CLAY LOAM 48"- 60" CLAY

NOTE: ALL SPS DESIGNS ARE FOR: 4-BEDROOM MANNAHM: DAILY SLOW = 440 GPD MN. SEPTIC PARK SIZE = 1250 GALLONS

LOT NO,	PERC TEST (PT) NO.	HOLE DEPTH	SOIL TYPE	SOAKED	1	TEST I	RUNS 3 I	4	
	PT1-1	9"	CLAY LOAM	YES	3 MIN.	B MIN:	9 MiN.		
1	PT2-1	9"	CLAY LOAM	YES	1 MIN.	1 MIN.	1 MIN.		
	PT3-1	12"	LOAN	YES	5 MIN.	7 MIN.	7 MIN.		
2	PT1~2	12"	CLAY LOAN	YES	1 MIV.	1 MIN.	1 MIN.		
	PT2-2	12"	CLAY LOAM	YES	7 MIN.	8 MM.	9 MIN.	-	
3	PTI-3	12"	CLAY LOAM	YES	19 MIN.	20 MIN,	20 MIN.	· ·	
٥	PT2-3	5"	LOAM	YES	1 MIN.	3 MIN.	2 Min.	-	
	PT1-4	12"	CLAY LOAM	YES	16 MIN.	19 M IN.	19 MIN.	-	
	PT2-4	12"	CLAY LOAM	YES	26 MIN.	43 MIN.	44 MIN.	-	
	-	-		-	_	1	_	-	
	P12-5	12"	CLAY LOAM	YES	1 MIN.	3 MIN.	4 MIN.		
	PT16	15"	CLAY ROCKY	YES	1 MIN.	1 MIN.	2 MIN.		
6	₽T2−6	16"	CLAY ROCKY	YES	1 MIN.	2 MIN.	2 MIN.		
U	PT3-6		CLAY ROCKY					_	
		12"	LOAM	YES	tō MIN.	17 MIN.	17 MIN.		
7	PT17	12"	CLAY LOAM	YES	17 MIN.	22 MIN.	22 MIN.	22 M:N.	
	PT2 · 7	7"	SANDY LOAM	YES -	1 MIN.	2 MIN.	3 MIN.	72-2	
8	PT1-8	12"	SANDY LOAM	YES	1 MIN.	1 MIN.	1 MIN.	4	
	PT2 - 8	12"	SANDY LOAM	YES	4 MIN.	4 MOV.	5 MIN.		
9	PTI-9	12"	SANDY LOAM	YES	1 MIN.	1 MIN.	2 MIN.	-	
٦	PT2-9	12"	SANDY LOAM	YES	1 MIN.	1 MAN.	1 MIN.	-	4.2
40	PT1-10	12"	SANDY LOAM	YES	2 MIN.	3 MIN.	3 MIN.	-	
10	P12-10	12"	SANDY LOAM	YES	1 MRN.	3 MIN.	3 MIN,	-	
	PT:~11	6"	GRITTY LOAM	YES	6 MIN.	8 MIN.	9 MIN.	-	
11	PT2-11	6"	CRITTY LOAN	YES	4 MIN.	6 MIN.	7 MiN.	-	755
	PT3~11	12"	LOAM	YES	8 M:N.	8 MIN.	8 MIN.		-
	PT1-12	24"	GRITTY LOAM	YES	11 MN.	11 MiN.	11 MIN.	_	
12	PT212	24"	GRITTY LOAN	YES	a Min.	9 MIN.	9 MIN.	_	
	PT1-13			-				-	
		24"	GRITTY LOAM	YES	12 MIN.	13 MIN.	13 MIN.	* -	
13	PT2-13	24"	GRITTY LOAM	YES	13 MIN.	14 MIN.			
	PT3-13	.8"	SANDY LOAM	YES	5 NIN.	17 MIN.	17 MIN.	16 MIN.	
	PT413	8"	SANDY LOAM	YES	4 MR4.	7 MIN.	6 MIN.	-	
14	PT1-14	12"	CLAY LOAM	YES	3 MIN.	7 MIN.	8 MIN.	-	
	PT2-14	12"	CLAY LOAM	YES	5 MIN.	8 MIN.	.9 MIN.	- 1	
15	PT115	12"	CLAY LOAM	YES	13 MIN.	17 MIN.	18 MiN.	- '	
IJ	PT2-15	12"	CLAY LOAM	YES	10 MIN.	13 MIN.	13 MIN.	-	
40	PT1-18	12"	SANDY LOAN	YES	1 MIN.	2 MIN.	2 MIN.	-	
16	PT2-16	12"	SANDY LOAN	YES	1 MIN.	1 MIN.	1 MIN.	-	
}	PT1-17	12"	SANDY LOAM	YES	1 MIN.	2 MIN.	2 MIN.		
17	PT2-17	12"	SANDY LOAM	YES.	4 MIN.	5 MiN.	6 MIN.	_	
	PT1-18	12"	SANDY LOAM	YES	1 MIN.	2 MIN.	2 MIN.		1
18	PT2-18	12"	SANDY LOAM	ΨES	1 MIN.	1 MIN.	2 MIN.	-	
	PT1-19	12"	SANDY LOAM	YES	6 MIN.	6 MIN.	6 MIN.	_	
	PT2-19	12°		YES					
19			SANDY LOAM		1 MIN.	1 MIN.	1 MIN.		
^	PT3: 19	12"	CLAY LOAM	YES	8 Mile.	8 MIN,	8 MIN.		
	PT4-19	12"	CLAY LOAM	YES	5 MIN.	6 M:N.	6 MIN.	-	
20	PT1-20	12"	CLAY LOAM	YES	1 MIN.	1 MIN.	2 MIN.	-	
	PT2-20	12"	CLAY LOAM	YES	1 MIN.	5 MIN.	6 MIN.	-	
21	PT1-21	. 6"	CLAY LOAM	YES	12 MIN.	14 MIN.	15 MIN.	-	
- '	P12-21	6"	CLAY LOAM	YES	a MIN.	9 MIN.	10 MIN.	-	
	PT3-21	12"	LUAN	YES	12 MIN.	13 MIN.	13 MIN.	-	
22	P11 22	9"	LOAM	YES	43 MIN.	42 MIN.	40 MIN.	-	
22	PT2-22	9"	LOAM	YES	30 MIN,	40 MIN.	: 42 MIN.	-	
	PT3-22	:2"	CLAY LOAM	YES	35 Min.	37 MIN.	37 MIN.	_	
	PT1-23	12"	CLAY LOAM	YES	27 MIN.	36 MIN.	38 MIN.	-	
	PT2-23	12"	CLAY LOAM	YES	22 MIN.	24 MIN.	25 MtN.	-	
23	P13-23	12"	CLAY LOAM W/PEBBLES	YES	15 MIN.	15 MIN.	15 MrN.		
٠	PT4-23	12"	CLAY LOAM	YES	10 MIN.	12 MIN.	12 MIN.	12 MIN.	1.0
	PT1=24	12"	CLAY LOAM	YES	20 MIN.	30 MIN.	31 MIN.	_	
24	PT2-24	12"	CLAY LOAM	YES	17 MIN.	21 MIN.	22 MIN.		
					a. Milly,		La latit.) ::



People. Purpose. Place. 40 Long Alley p: 518-587-8100
Saratoga Springs f: 518-587-0180
NY 12866 www.thelagroup.com

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Prepared for:

TERRAMOR.

550 N 31st Street Billings, MT 59101

Civil Engineer: C.T. Male Associates 50 Century Hill Drive Latham, NY 12110

Architect: **DGC Architects** 40 Church Street, Studio A Ellsworth, ME 04605

Traffic Engineer: 80 Wolf Road, Suite 300, Albany, NY 12205

Surveyor: Ausfeld & Waldruff 323 Clinton Street Schenectady, NY 12305

Project Title:

Terramor Catskills

NY ROUTE 212 Saugerties, NY 12477

ISSUED FOR: SITE PLAN APPLICATION


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sign:			MJT/KAC	
awn:	BAS	Ch'k'd:	MJ⊤	
ite:	07/01/2022	Scale:	1"=120'	
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Drawing Title

Soils Inventory Plan

Drawing No.

L-1.1

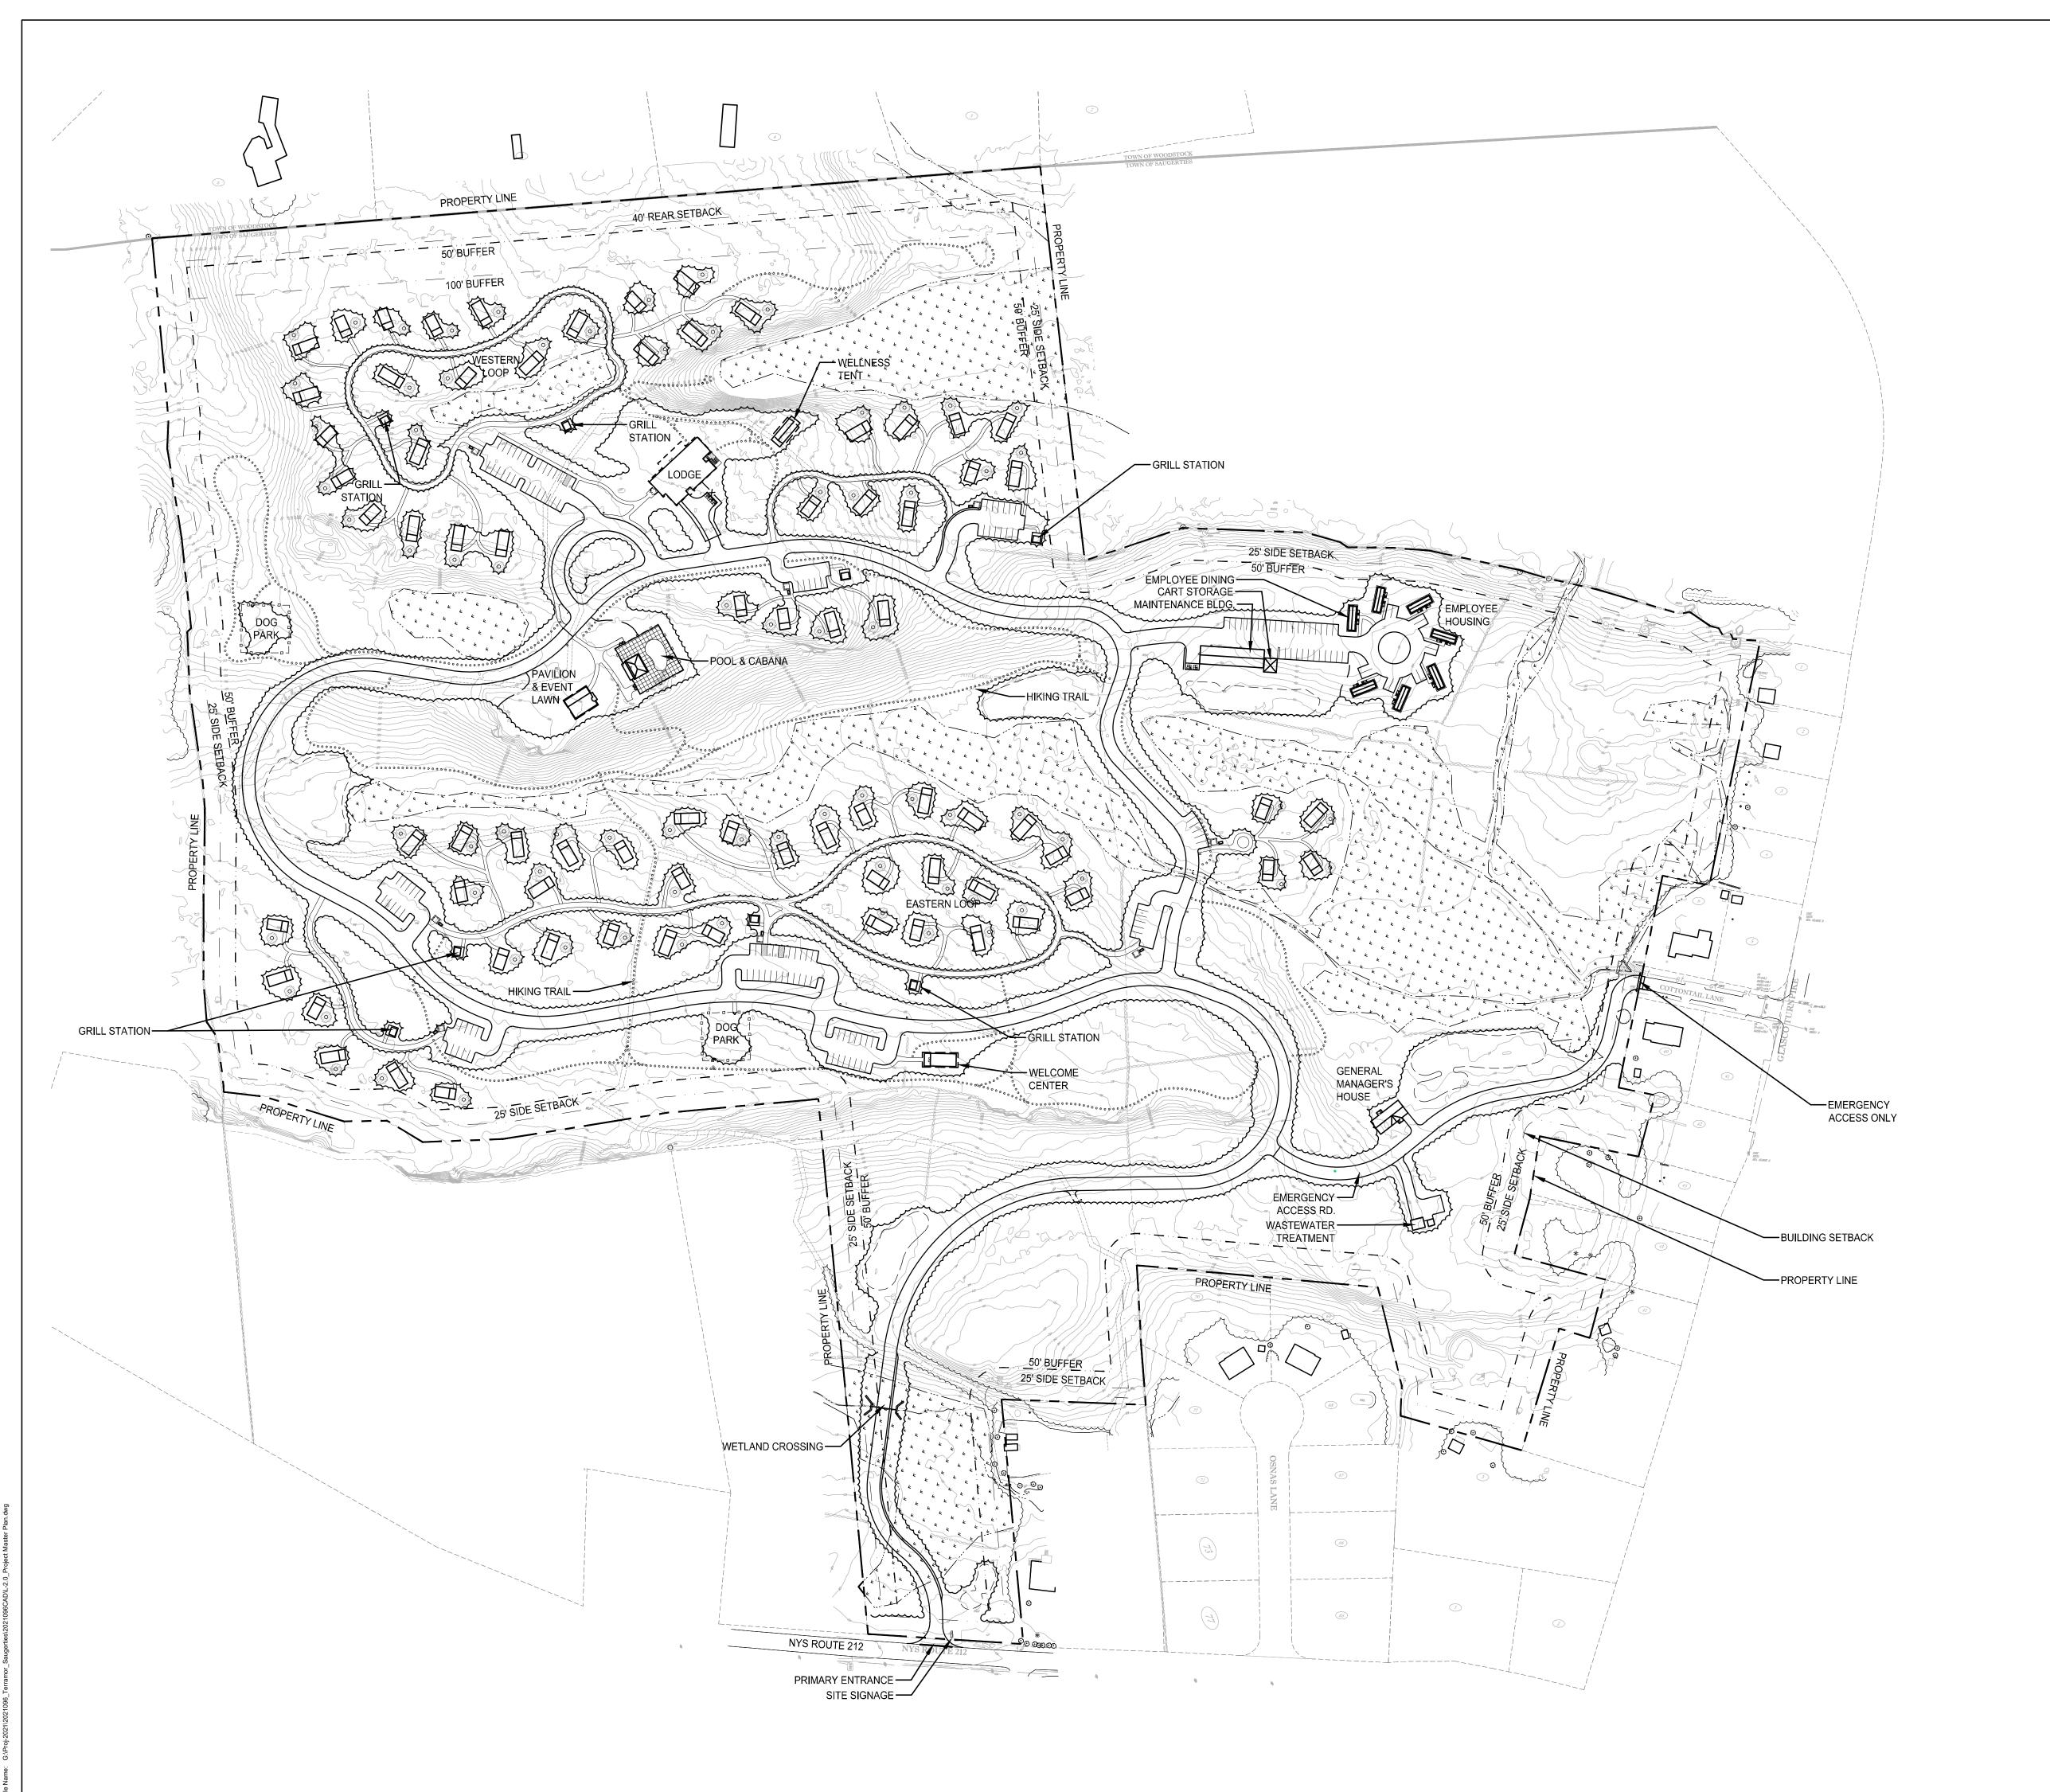

The LA GROUP
Landscape Architecture & Engineering P.C.

People. Purpose. Place.

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NY ROUTE 212 Saugerties, NY 12477

ISSUED FOR: SITE PLAN APPLICATION

KAC
MJT
120'


: Description: Date:

Drawing Title

OVERALL SITE PLAN PLAN

Drawing No.

L-2.0

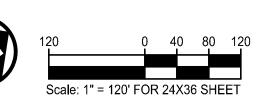

PROPERTY LINE

BUILDING SETBACK

50' FACILITIES BUFFER

GLAMPING TENT

LEGEND

\(\psi\) \(\

EXISTING STONE WALL