## **GENERAL NOTES**

- EXISTING CONDITIONS DATA WAS COMPILED USING A SURVEY TITLED "ATLA/NPS LAND TITLE BOUNDARY SURVEY OF THE LANDS OF SAUGERTIES DEVELOPERS LLC" BY AUSFELD & WALDRUFF LAND SURVEYORS, DATED OCTOBER 26, 2021.
- PRIOR TO COMMENCING ANY EXCAVATION WORK, THE CONTRACTOR SHALL CONTACT U.F.P.O. (1-800-962-7962) AND THE PROPER LOCAL AUTHORITIES OR RESPECTIVE UTILITY COMPANY HAVING JURISDICTION TO CONFIRM THE LOCATION OF ALL EXISTING UTILITIES BEFORE COMMENCING WORK. ANY COSTS INCURRED BY THE CONTRACTOR DUE TO FAILURE TO CONTACT THE PROPER AUTHORITIES SHALL BECOME THE RESPONSIBILITY OF THE CONTRACTOR.
- 3. PRIOR TO DEMOLITION, THE CONTRACTOR SHALL RETAIN THE SERVICES OF A UTILITY LOCATING SERVICE IN ACCORDANCE WITH SPECIFICATION, THAT SHALL BE RESPONSIBLE FOR LOCATING AND DOCUMENTING ALL UNDERGROUND UTILITIES.
- 4. THE LOCATIONS OF ALL UNDERGROUND UTILITIES SHOWN ON THESE PLANS ARE DIAGRAMMATIC ONLY, CONTRACTOR SHALL COORDINATE LOCATION OF ALL UTILITIES (LINES, DUCTS, CONDUITS, SLEEVES, FOOTINGS, ETC.) WITH LOCATIONS OF PROPOSED LANDSCAPE ELEMENTS (WALLS, FENCE, FOOTINGS, TREE ROOTBALLS, PROPOSED LIGHTING FOOTINGS, ETC.). EXCAVATION REQUIRED WITHIN PROXIMITY OF UTILITY LINES SHALL BE DONE BY HAND. ANY
- 5. THE GENERAL CONTRACTOR SHALL VERIFY ALL SITE CONDITIONS IN THE FIELD AND REPORT ANY DISCREPANCY BETWEEN THE PLANS AND THE ACTUAL FIELD CONDITIONS TO THE OWNER.

DAMAGE AND INCURRED COSTS DUE TO FAILURE OF THE CONTRACTOR TO CONTACT THE PROPER AUTHORITIES SHALL BE BORNE BY THE CONTRACTOR.

- 6. LIMIT OF WORK LINE IS NOTED ON DRAWINGS. CONTRACTOR IS RESPONSIBLE FOR ALL DAMAGE DUE TO OPERATIONS INSIDE AND OUTSIDE OF THE LIMITS OF WORK LINE. ANY AREAS OUTSIDE THE LIMIT OF WORK THAT ARE DISTURBED SHALL BE RESTORED TO ITS ORIGINAL CONDITION AT NO ADDITIONAL COST TO THE OWNER. CONTRACTOR SHALL MEET LINE AND GRADE OF EXISTING CONDITIONS AT LIMIT OF WORK LINE. IF NO LIMIT OF WORK IS SHOWN, THE PROPERTY LINE SHALL BE THE LIMIT OF WORK.
- 7. THE CONTRACTOR SHALL ESTABLISH PERMANENT BENCH MARKS. MAINTAIN ALL ESTABLISHED BOUNDS AND BENCH MARKS AND REPLACE ANY WHICH ARE DESTROYED OR DISTURBED.
- 8. CONTRACTOR SHALL EMPLOY SPECIAL CARE IN SCHEDULING CONSTRUCTION SO AS TO MAINTAIN EXISTING VEHICULAR TRAFFIC PATTERNS, AND MINIMIZE DISRUPTION TO SURROUNDING PEDESTRIAN TRAFFIC. CONTRACTOR SHALL EMPLOY SPECIAL CARE TO PROTECT SAFETY OF PEDESTRIANS INSIDE AND OUTSIDE OF THE LIMIT OF WORK LINE.
- 9. IT IS THE CONTRACTOR'S RESPONSIBILITY TO ENSURE ALL REQUIRED PERMITS FROM ALL JURISDICTIONS AFFECTED BY THIS WORK ARE IN PLACE PRIOR TO CONSTRUCTION. FOR PERMITS ALREADY ISSUED, CONTRACTOR SHALL OBTAIN COPIES OF PERMITS AND STRICTLY ADHERE TO PERMIT CONDITIONS. PERMITS THAT ARE OUTSTANDING SHALL BE SECURED BY THE CONTRACTOR AND COORDINATED WITH THE DIRECTOR'S REPRESENTATIVE.
- 10. ALL ALTERATIONS TO THESE DRAWINGS MADE IN THE FIELD DURING CONSTRUCTION SHALL BE RECORDED BY THE CONTRACTOR ON "RECORD DRAWINGS," AS SPECIFIED.
- 11. STORAGE AREAS FOR THE GENERAL CONTRACTOR'S EQUIPMENT AND MATERIALS SHALL BE LOCATED WITHIN THE LIMITS OF WORK AS SHOWN ON THE PLANS OR AS APPROVED BY THE OWNER.
- 12. SHOULD ANYTHING BE OMITTED FROM THE PLANS WHICH IS NECESSARY FOR A COMPLETE UNDERSTANDING OF THE WORK, OR SHALL ANY ERROR APPEAR IN THE VARIOUS INSTRUMENTS FURNISHED OR IN THE WORK BY OTHER CONTRACTORS AFFECTING THE WORK COVERED HEREBY, THE CONTRACTOR SHALL AND WILL PROMPTLY NOTIFY THE DIRECTOR'S REPRESENTATIVE, AND IN THE EVENT OF THE CONTRACTOR'S FAILURE TO DO SO, HE SHALL AND WILL MAKE GOOD OF ANY DAMAGE OR DEFECT IN HIS WORK CAUSED THEREBY.
- 13. CONTRACTOR SHALL MAINTAIN THE INTEGRITY OF ALL EXISTING INFRASTRUCTURE FOR THE DURATION OF CONSTRUCTION. CONTRACTOR SHALL PROTECT AND SUSTAIN IN NORMAL SERVICE ALL EXISTING UTILITIES, STRUCTURES, EQUIPMENT, ROADWAYS AND DRIVEWAYS.
- 14. THE CONTRACTOR SHALL BE RESPONSIBLE TO COORDINATE HIS EFFORTS OF DEMOLITION, REMOVALS AND OR RELOCATION WORK WITH ALL TRADES. CONSULT ALL DRAWINGS AND SPECIFICATIONS FOR ADDITIONAL COORDINATION REQUIREMENTS BEFORE COMMENCING CONSTRUCTION.
- 15. CONTRACTOR TO COMPLY WITH ALL OSHA AND OTHER STATE AND LOCAL SAFETY REQUIREMENTS DURING CONSTRUCTION.
- 16. CONTRACTOR SHALL MAINTAIN NECESSARY TRAFFIC CONTROL DEVICES, DRUMS, DELINEATORS, SIGNS, FENCES, AND BARRICADES IN ACCORDANCE WITH THE LATEST EDITION OF THE NATIONAL MUTCD WITH NYS SUPPLEMENT TO PROPERLY PROTECT WORK, EQUIPMENT, PERSONS, AND PROPERTY FROM DAMAGE. ALL DAILY TRAFFIC IN THE VICINITY OF THE SITE SHALL NOT BE IMPEDED.

### SITE PREPARATION AND SITE DEMOLITION NOTES

TO THE OWNER, SHALL BE LEGALLY DISPOSED OF OFF-SITE BY THE CONTRACTOR.

- PRIOR TO CONSTRUCTION, CONTRACTOR SHALL ARRANGE PRE-CONSTRUCTION MEETING WITH DIRECTOR'S REPRESENTATIVE TO REVIEW ALL APPLICABLE PERMIT CONDITIONS, THE CONSTRUCTION PLANS AND GENERAL CONSTRUCTION SCHEDULE.
- 2. CONTRACTOR SHALL REFER TO PROJECT STORMWATER POLLUTION PREVENTION PLAN (SWPPP) PRIOR TO MOBILIZATION / CONSTRUCTION. ALL WORK SHALL BE IN ACCORDANCE WITH THE PROJECT SWPPP. ALL EROSION CONTROL MEASURES SHALL BE IN PLACE PRIOR TO ANY EARTH DISTURBING ACTIVITIES. REFER TO PROJECT PLANS, NOTES AND DETAILS.
- THE CONTRACTOR'S ATTENTION IS DIRECTED TO THE GENERAL NOTES, UTILITY NOTES, SPECIFICATIONS, AND UTILITY LOCATING SERVICE REQUIREMENTS. NO WORK SHALL COMMENCE UNTIL UNDERGROUND UTILITIES WITHIN THE SITE HAVE BEEN IDENTIFIED AND LOCATED.
- 4. ALL REFUSE, DEBRIS AND MISCELLANEOUS ITEMS TO BE REMOVED, THAT ARE NOT TO BE STOCKPILED FOR LATER USE ON THE PROJECT OR DELIVERED
- 5. CONTRACTOR SHALL STRIP AND STOCKPILE EXISTING TOPSOIL TO FULL DEPTH WITHIN LIMIT OF GRADING BEFORE COMMENCING EXCAVATION AND
- GRADING OPERATIONS. TOPSOIL SHALL NOT BE REMOVED FROM THE SITE, UNLESS APPROVED BY THE DIRECTOR'S REPRESENTATIVE.
- 6. THE CONTRACTOR SHALL COORDINATE ALL ADJUSTMENT OR ABANDONMENT OF UTILITIES WITH THE RESPECTIVE UTILITY COMPANY AND PAY ALL ASSOCIATED COSTS.
- 7. CONTRACTOR SHALL ABIDE BY ALL PERMITS THAT MAY BE REQUIRED FROM ALL JURISDICTIONS AFFECTED BY THIS WORK.
- 8. CONTRACTOR SHALL PROTECT AND SUSTAIN IN NORMAL SERVICE ALL EXISTING UTILITIES, STRUCTURES, EQUIPMENT, ROADWAYS AND DRIVEWAYS.
- BEFORE ANY CLEARING IS DONE. THE CONTRACTOR SHALL ARRANGE A CONFERENCE ON THE SITE WITH THE LANDSCAPE ARCHITECT TO IDENTIFY TREES WHICH ARE TO BE PROTECTED OR REMOVED. DO NO CLEARING WITHOUT A CLEAR UNDERSTANDING OF EXISTING CONDITIONS TO BE PRESERVED.
- 10. AT ALL LOCATIONS WHERE EXISTING PAVEMENT ABUTS NEW CONSTRUCTION, THE EDGE OF THE EXISTING PAVEMENT SHALL BE SAW CUT TO A CLEAN, SMOOTH AND SHARP EDGE AND PROTECTED UNTIL ABUTTING MATERIALS ARE INSTALLED.
- 11. IT IS THE RESPONSIBILITY OF THE CONTRACTOR TO COORDINATE WITH THE DIRECTOR'S REPRESENTATIVE ON ALL MATERIALS TO BE REMOVED AND RECYCLED/DISPOSED OF OFF SITE. ALL HANDLING OF MATERIALS TO BE REMOVED, RECYCLED, OR DISPOSED OF MUST BE DONE SO IN A SAFE, LEGAL MANNER, IN ACCORDANCE WITH ALL LOCAL, COUNTY, STATE, FEDERAL AND ANY OTHER APPLICABLE REGULATIONS.
- 12. ALL ITEMS REQUIRING REMOVAL SHALL BE REMOVED TO FULL DEPTH, INCLUDING BASE MATERIAL AND FOOTINGS OR FOUNDATIONS, UNLESS OTHERWISE NOTED.
- 13. EXISTING ITEMS INDICATED TO BE SALVAGED OR STOCKPILED SHALL BE CAREFULLY REMOVED AND STORED AS DIRECTED BY THE DIRECTOR'S REPRESENTATIVE.
- 14. TREE, SHRUB AND VEGETATION REMOVAL SHALL INCLUDE THE FELLING, CUTTING, GRUBBING OUT OF ENTIRE ROOT SYSTEM AND SATISFACTORY OFF-SITE DISPOSAL OF ALL TREES, SHRUBS, STUMPS, VEGETATIVE AND EXTRANEOUS DEBRIS PRODUCED THROUGH THE REMOVAL OPERATIONS. PITS/HOLES REMAINING AFTER GRUBBING OPERATIONS SHALL BE BACKFILLED AND COMPACTED AS SPECIFIED.
- 15. THE CONTRACTOR IS RESPONSIBLE FOR VERIFYING EXISTING CONDITIONS AND PERFORMING ALL SITE DEMOLITION AND REMOVALS REQUIRED TO FACILITATE PROPOSED CONSTRUCTION.
- 16. FIELD VERIFY EXISTING UTILITIES AND RESPECTIVE CONNECTIONS AND REPORT FINDINGS TO DIRECTOR'S REPRESENTATIVE, UPON AUTHORIZATION, REMOVE AND DISPOSE FENCE AND UTILITIES AND ABANDON CONNECTION IN ACCORDANCE WITH CODES AND REQUIREMENTS OF AUTHORITIES HAVING JURISDICTION, IF UTILITIES MUST REMAIN IN SERVICE, PROTECT AGAINST DAMAGE AND MAINTAIN INTEGRITY OF SYSTEM.

# LAYOUT NOTES:

- ALL LINE AND GRADE INFORMATION SHALL BE LAID OUT BY A NEW YORK STATE LICENSED SURVEYOR ENGAGED BY THE CONTRACTOR.
- 2. ALL NEW WORK SHALL BE STAKED OUT PRIOR TO CONSTRUCTION. THE DIRECTOR'S REPRESENTATIVE SHALL BE NOTIFIED OF ANY DISCREPANCIES. FIELD ADJUSTMENTS MUST BE APPROVED BY THE DIRECTOR'S REPRESENTATIVE PRIOR TO CONSTRUCTION.
- 3. ALL LINES AND DIMENSIONS ARE PARALLEL OR PERPENDICULAR TO THE LINES FROM WHICH THEY ARE MEASURED UNLESS OTHERWISE NOTED.
- 4. DIMENSIONS TO CURBS ARE FROM FACE OR BOTTOM OF CURB TO FACE OR BOTTOM OF CURB.
- 5. FIELD ADJUSTMENTS MUST BE APPROVED BY THE DIRECTOR'S REPRESENTATIVE AND IF NECESSARY APPROPRIATE MUNICIPAL OFFICIALS.
- 6. ALL PROPOSED WALKS, PAVEMENTS, LIGHTS AND SITE IMPROVEMENTS SHALL BE STAKED IN THE FIELD FOR APPROVAL BY THE DIRECTOR'S REPRESENTATIVE PRIOR TO CONSTRUCTION.
- CONTRACTOR SHALL COORDINATE LOCATION OF ALL UTILITIES (LINES, DUCTS, CONDUITS, SLEEVES, FOOTINGS, ETC.) WITH LOCATIONS OF PROPOSED LANDSCAPE ELEMENTS (WALLS, FENCE, FOOTINGS, TREE ROOTBALLS, PROPOSED LIGHTING FOOTINGS, ETC.). CONTRACTOR SHALL REPORT ANY DISCREPANCIES TO DIRECTOR'S REPRESENTATIVE PRIOR TO CONTINUING WORK.
- ALL EXISTING UTILITIES ARE SHOWN IN THEIR RELATIVE POSITION. CONTRACTOR IS RESPONSIBLE FOR VERIFYING THE VERTICAL & HORIZONTAL
- POSITION OF EXISTING UTILITIES PRIOR TO CONSTRUCTION.

# **EROSION AND SEDIMENT CONTROL NOTES**

- 1. THE CONTRACTOR'S ATTENTION IS DIRECTED TO THE REQUIREMENTS OF THE NEW YORK STATE DEPARTMENT OF ENVIRONMENTAL CONSERVATION (NYSDEC) STATE POLLUTANT DISCHARGE ELIMINATION SYSTEM SPDES GENERAL PERMIT FOR STORMWATER DISCHARGES FROM CONSTRUCTION ACTIVITY GP-0-20-001, THE STORMWATER POLLUTION PREVENTION PLAN (SWPPP) DEVELOPED FOR THIS PROJECT IS IN ACCORDANCE WITH THE GENERAL PERMIT FOR STORMWATER DISCHARGES FROM CONSTRUCTION ACTIVITY.
- 2. ALL CONSTRUCTION SHALL BE IN STRICT ACCORDANCE WITH THE STORMWATER POLLUTION PREVENTION PLAN (SWPPP), AND GENERAL CONSTRUCTION SEQUENCING. PRIOR TO CONSTRUCTION, THE CONTRACTOR SHALL REVIEW THE PROJECT SWPPP FOR SPECIFIC REQUIREMENTS REGARDING EROSION AND SEDIMENT CONTROL AND STORMWATER MANAGEMENT. A COPY OF THE SWPPP MUST BE MAINTAINED ON THE PROJECT SITE IN AN ACCESSIBLE LOCATION AT ALL TIMES DURING CONSTRUCTION.
- 3. PRIOR TO ANY SITE WORK, ALL CONTRACTORS AND SUBCONTRACTORS RESPONSIBLE FOR CONSTRUCTION, REPAIR, AND MAINTENANCE OF ANY EROSION AND SEDIMENT CONTROLS OR STORMWATER DEVICES MUST SIGN/CERTIFY THE SWPPP AND IDENTIFY A 'TRAINED CONTRACTOR'.
- 4. PRIOR TO BEGINNING EARTHWORK ACTIVITY, THE CONTRACTOR SHALL SUBMIT A MOBILIZATION PLAN SHOWING PROPOSED STOCKPILE AND STAGING AREAS, HAUL/ACCESS ROADS, FIELD OFFICES AND EQUIPMENT STORAGE AREAS, AND A SCHEDULE DETAILING THE STAGING OF CONSTRUCTION TO THE QUALIFIED INSPECTOR (SWPPP INSPECTOR) AND DIRECTOR'S REPRESENTATIVE FOR APPROVAL.
- 5. THE CONTRACTOR SHALL NOT DISTURB MORE THAN (5) ACRES AT ANY ONE TIME WITHOUT PRIOR WRITTEN AUTHORIZATION FROM NYSDEC. ALL DISTURBED AREAS THAT DO NOT MEET THE DEFINITION OF "FINAL STABILIZATION" AS LISTED IN THE NYSDEC SPDES GENERAL PERMIT FOR STORMWATER DISCHARGES MUST BE INCLUDED WHEN CALCULATING THE TOTAL AREA DISTURBED AT ANY ONE TIME. FINAL STABILIZATION CAN INCLUDE CRUSHED STONE, PAVEMENT, OR SEEDED LAWN WITH A MINIMUM DENSITY OF 80% COVERAGE.
- 6. EROSION CONTROL DEVICES SHALL BE INSPECTED DAILY AND MAINTAINED TO ENSURE SATISFACTORY PERFORMANCE AND COMPLIANCE WITH THE SWPPP.
- 7. IT IS THE CONTRACTOR'S RESPONSIBILITY TO CHECK THE SWPPP FOR INSPECTION REPORTS, AND IMMEDIATELY MAKE REPAIRS AND CORRECTIONS NOTED. REMEDIATION WORK THAT IS REQUIRED AS A RESULT OF FAILING TO MAKE REPAIRS SHALL BE PERFORMED BY THE CONTRACTOR AT NO ADDITIONAL COST TO THE OWNER.
- 8. ANY CHANGES TO THE SWPPP PROPOSED BY THE CONTRACTOR MUST BE APPROVED BY THE QUALIFIED INSPECTOR AND INCORPORATED INTO THE SWPPP PRIOR TO IMPLEMENTATION.

9. ANY DEVIATIONS FROM OR CONSTRUCTION CONFLICTS WITH THE PROJECT SWPPP SHALL BE IMMEDIATELY REPORTED TO THE DIRECTOR'S

- REPRESENTATIVE. IF THE CONTRACTOR PROPOSES A REVISED STAGING, SEQUENCING AND/OR MOBILIZATION PLAN, A MODIFIED PLAN MUST BE SUBMITTED TO THE QUALIFIED INSPECTOR FOR APPROVAL.
- 10. THE CONTRACTOR SHALL INITIATE TEMPORARY AND PERMANENT STABILIZATION MEASURES AS SOON AS PRACTICABLE IN ACCORDANCE WITH THE
- 11. ALL DISTURBED AREAS SHALL BE STABILIZED IN ACCORDANCE WITH THE PLANS AND PROJECT SWPPP. IN ADDITION TO WHAT IS SHOWN ON PLANS, ANY SLOPES GREATER THAN 3:1 DISTURBED AS PART OF CONSTRUCTION SHALL BE STABILIZED IN ACCORDANCE WITH PROJECT DETAILS AND SWPPP.
- 12. EROSION AND SEDIMENT CONTROL PROTECTIONS SHOWN ON THE PLANS REPRESENT THE MINIMUM MEASURES NECESSARY. ADDITIONAL MEASURES AND DEVICES MAY BE NEEDED DUE TO SITE SPECIFIC CONDITIONS OR CHANGING CONDITIONS DUE TO CONSTRUCTION, IN ORDER TO MAINTAIN COMPLIANCE WITH THE SWPPP AND GENERAL PERMIT, AND SHALL BE PROVIDED BY THE CONTRACTOR AT NO ADDITIONAL COST TO THE OWNER.
- 13. EROSION AND SEDIMENT CONTROL PRACTICES SHALL BE MAINTAINED IN PLACE UNTIL CONSTRUCTION IS COMPLETED AND THE AREA IS STABILIZED AND APPROVED BY THE QUALIFIED INSPECTOR.

# TYPICAL EROSION AND SEDIMENT CONTROL SEQUENCING

CONSTRUCTION ASSOCIATED WITH EROSION AND SEDIMENT CONTROL SHALL TYPICALLY PROCEED IN THE FOLLOWING SEQUENCE. ANY DEVIATIONS OR ADJUSTMENTS TO THE TYPICAL SEQUENCING SHALL BE APPROVED BY THE QUALIFIED INSPECTOR. ALL EROSION AND SEDIMENT CONTROL PRACTICES SHALL BE IMPLEMENTED IN STRICT ACCORDANCE WITH THE PROJECT STORMWATER POLLUTION PREVENTION PLAN, AND CONTRACT DOCUMENTS. PRE-CONSTRUCTION AND SITE PREPARATION

PRE CONSTRUCTION MEETING - PROTOCOL MAY BE MODIFIED BY DESIGNATED QUALIFIED INSPECTOR.

- 2. DEFINE INSPECTION SCHEDULE, REVIEW STORMWATER POLLUTION PREVENTION PLAN.
- 3. DEFINE LIMITS OF DISTURBANCE AND CLEARING LIMITS. 4. INSTALL TREE PROTECTION, AND WETLAND PROTECTION FENCE IF REQUIRED.
- 5. INSTALL STABILIZED CONSTRUCTION ACCESS AND INITIAL STAGING AREAS.
- 6. INSTALL PERIMETER EROSION CONTROL INCLUDING SILT FENCE, FILTER SOCKS, ETC.
- 7. CLEAR AND GRUB EXISTING VEGETATION.

#### TEMPORARY RUNOFF AND DRAINAGE CONTROL 8. TEMPORARILY STABILIZE CLEARED AREAS THAT WILL NOT BE DISTURBED WITHIN 14 DAYS

- 9. INSTALL ADDITIONAL PERIMETER EROSION CONTROL IN CLEARED AREAS AS NEEDED.
- 10. INSTALL INLET PROTECTION

#### EARTHWORK AND SITE CONSTRUCTION 11. STRIP & STOCKPILE TOPSOIL.

- 12. INSTALL INFRASTRUCTURE, INCLUDING CATCH BASINS WITH INLET PROTECTION, PIPING, AND PERMANENT DRAINAGE STRUCTURES.
- 13. PERFORM ROUGH GRADING.
- TEMPORARY STABILIZATION OF WORK AREA
- 14. STABILIZE ALL BARE SOIL AREAS AS SOON AS PRACTICAL AND IN ACCORDANCE WITH THE SWPPP.
- INSPECT ALL PERIMETER EROSION CONTROL AND REPAIR AS NEEDED AND/OR DIRECTED. 16. INSTALL/REPAIR ALL INLET / OUTLET PROTECTION, AND STRUCTURAL STABILIZATION SUCH AS EROSION CONTROL BLANKETS, RIP RAP, AND CHECKDAMS.

# 17. REMOVE SEDIMENT FROM TRAPPING DEVICES IN ACCORDANCE WITH THE SWPPP.

- PERFORM SOIL RESTORATION, DECOMPACTION AND FINISHED GRADING.
- 19. INSTALL SOD OR SEED, MULCH ALL GRASSED AREAS AND STABILIZE SLOPES IN ACCORDANCE WITH THE SWPPP AND CONTRACT DOCUMENTS.
- 20. INSTALL PROPOSED PLANT MATERIALS.
- 21. RECEIVE CERTIFICATION OF FINAL STABILIZATION FROM QUALIFIED INSPECTOR.
- 22. CLEAN ALL STORMWATER SYSTEMS OF SEDIMENT, TRASH, AND DEBRIS.
- 23. REMOVE TEMPORARY EROSION AND SEDIMENT CONTROL MEASURES ONLY WHEN WORK AREAS ARE APPROVED AS STABILIZED BY THE QUALIFIED

# PLANTING NOTES:

INSPECTOR.

- 1. ALL NEW PLANT MATERIAL SHALL CONFORM TO THE MINIMAL GUIDELINES ESTABLISHED BY THE AMERICAN STANDARD FOR NURSERY STOCK PUBLISHED BY THE AMERICAN ASSOCIATION OF NURSERYMEN, INC. ALL NEW MATERIAL FOR THE PROJECT SHALL BE OF SPECIMEN QUALITY UNLESS APPROVED OTHERWISE BY DIRECTOR'S REPRESENTATIVE.
- 2. ALL CONTAINER GROWN PLANTS SHALL BE PREMIUM QUALITY AND APPEAR 'FULL' IN HEIGHT AND WIDTH WITHIN THE POT. PLANTS DEEMED SUBSTANDARD IN SIZE SHALL BE REJECTED.
- 3. ALL NEW PLANTS TO BE BALLED AND BURLAPPED OR CONTAINER GROWN UNLESS OTHERWISE NOTED ON PLANT LIST.
- 4. THE CONTRACTOR SHALL SUPPLY ALL NEW PLANT MATERIAL IN QUANTITIES SUFFICIENT TO COMPLETE THE PLANTING SHOWN ON THE DRAWINGS.
- 5. IN GENERAL, PLANT SPECIES SUBSTITUTIONS WILL NOT BE ACCEPTED. IF SPECIFIED MATERIAL IS NOT OBTAINABLE, CONTRACTOR SHALL SUBMIT PROOF OF NON-AVAILABILITY TO LANDSCAPE ARCHITECT ALONG WITH PROPOSED SUBSTITUTION. ANY PROPOSED SUBSTITUTIONS OF PLANT SPECIES SHALL BE MADE WITH PLANTS OF EQUIVALENT OVERALL FORM, HEIGHT, SIZE, BRANCHING HABIT, FLOWER, LEAF, COLOR, FRUIT AND CULTURE, AND ONLY AFTER WRITTEN APPROVAL OF THE LANDSCAPE ARCHITECT.
- 6. CONTRACTOR SHALL LOCATE AND VERIFY ALL EXISTING UTILITY LINES PRIOR TO PLANTING AND SHALL REPORT ANY CONFLICTS TO THE DIRECTOR'S REPRESENTATIVE.
- 7. NEW SHRUBS AND GROUND COVER SHALL BEAR THE SAME RELATIONSHIP TO GRADE AS IT BORE TO PREVIOUS GRADE. NO TREES SHALL BE PLANTED BEFORE ACCEPTANCE OF ROUGH GRADING.
- 8. ALL PLANT BEDS TO RECEIVE THREE INCHES (3") OF BARK MULCH UNLESS OTHERWISE SPECIFIED.
- 9. ALL AREAS PROPOSED FOR LAWN SEEDING SHALL RECEIVE A MINIMUM OF 6" OF SUITABLE TOPSOIL PRIOR TO SEEDING. ALL DISTURBED AREAS NOT SCHEDULED FOR PROPOSED WORK SHALL RECEIVE FOUR INCHES (4") OF SUITABLE TOPSOIL PRIOR TO SEEDING.
- 10. PLANTS SHALL BE DELIVERED ONLY AS THEY CAN BE INSTALLED IN REASONABLE TIME. ALL PLANTS ARE SUBJECT TO INSPECTION AT DELIVERY BY THE LANDSCAPE ARCHITECT/DIRECTOR'S REPRESENTATIVE.
- 11. IF DISCREPANCIES EXIST BETWEEN THE NUMBER OF PLANTS DRAWN ON THE PLANTING PLAN AND THE NUMBER OF PLANTS IN THE PLANT LIST, THE PLANTING PLAN SHALL GOVERN.

12. STAKE LOCATION OF ALL PROPOSED PLANTING FOR APPROVAL BY LANDSCAPE ARCHITECT PRIOR TO THE COMMENCEMENT OF PLANTING.

- **GRADING NOTES**
- 1. ALL PROPOSED GRADES SHALL BE SET IN THE FIELD BY A NEW YORK STATE LICENSED LAND SURVEYOR.
- 2. CONTRACTOR SHALL ESTABLISH PERMANENT SECONDARY BENCHMARKS PRIOR TO THE START OF CONSTRUCTION, ALL SECONDARY BENCHMARKS SHALL BE SO LOCATED THAT THEY WILL NOT BE DISTURBED BY CONSTRUCTION.
- 3. PITCH EVENLY BETWEEN SPOT GRADES. ALL PAVED AREAS MUST PITCH TO DRAIN AT A MINIMUM SLOPE OF ONE-EIGHTH INCH (1/8") PER FOOT.
- 4. MAXIMUM CROSSPITCH OF ALL SIDEWALKS IS 2%. RAMPS SHALL NOT EXCEED 1 IN 12 OR 30' IN LENGTH. ANY DISCREPANCIES NOT ALLOWING THIS TO OCCUR SHALL BE REPORTED TO THE DIRECTOR'S REPRESENTATIVE PRIOR TO CONTINUING WORK.
- 5. SITE PAVEMENT SHALL MEET ALL BUILDING DOOR THRESHOLDS FLUSH AND IN ACCORDANCE WITH ADA GUIDELINES.
- 6. ALL PROPOSED TOP OF VERTICAL CURB ELEVATIONS ARE SIX INCHES (6") ABOVE BOTTOM OF CURB UNLESS SHOWN OTHERWISE.
- 7. WHERE NEW PAVING MEETS EXISTING PAVING, NEW PAVING SHALL MEET THE LINE AND GRADE OF THE EXISTING PAVING.
- 8. SET CATCH BASIN AND DROP INLET RIMS TO DRAIN SURROUNDING AREAS AND AT SAME PITCH AS SLOPING PAVEMENT. IF STRUCTURE IS SHOWN ADJACENT TO CURB, SET GRATE TIGHT TO FACE OF CURB.
- 9. EXCAVATION REQUIRED WITHIN 3 FEET OF EXISTING UTILITY LINES SHALL BE DONE BY HAND. CONTRACTOR SHALL REPAIR ANY DAMAGE TO EXISTING UTILITY LINES OR STRUCTURES INCURRED DURING CONSTRUCTION OPERATIONS AT NO ADDITIONAL COST TO OWNER.
- 10. ALL EARTHWORK SHALL BE IN ACCORDANCE WITH THE GEOTECHNICAL REPORT AND SPECIFICATIONS.
- 11. GRADE AREAS ADJACENT TO BUILDING LINES TO DRAIN AWAY FROM STRUCTURE AND PREVENT PONDING. FINISH SURFACES SHALL BE FREE FROM IRREGULAR SURFACE CHANGES.
- 12. EXCAVATION REQUIRED WITHIN DRIP LINE OF TREES DESIGNATED TO REMAIN SHALL BE DONE BY HAND. PLANT MATERIALS DAMAGED BY CONTRACTOR SHALL BE REPLACED IN KIND.
- 13. SLOPE SIDES OF EXCAVATIONS TO COMPLY WITH LOCAL CODES AND ORDINANCES HAVING JURISDICTION AND OSHA REGULATIONS. MAINTAIN SIDE SLOPES OF EXCAVATIONS IN A SAFE CONDITION UNTIL COMPLETION OF BACKFILLING.
- 14. THE GENERAL CONTRACTOR SHALL MAINTAIN OR ADJUST TO NEW FINISH GRADE AS NECESSARY ALL UTILITY AND SITE STRUCTURES SUCH AS LIGHT POLES, SIGN POLES, MAN HOLES, CATCH BASINS, HAND HOLES, WATER AND GAS GATES, HYDRANTS, ETC., FROM MAINTAINED UTILITY AND SITE SYSTEMS UNLESS OTHERWISE NOTED ON THE UTILITY DRAWINGS OR AS DIRECTED BY THE DIRECTOR'S REPRESENTATIVE.
- 15. CONTRACTOR SHALL BLEND NEW EARTHWORK SMOOTHLY INTO EXISTING, PROVIDING VERTICAL CURVES OR ROUNDINGS AT ALL TOP AND BOTTOM OF SLOPES.

SEED MIXES:

AWN - 'COMMERCIAL CONSERVATION SEED MIX'

AND 'CONSERVATION SHADE MIX' BY ERNST

SEEDS, OR SIMILAR BLEND OF PERENNIAL RYE.

REMARKS/SPACING

2"-2 1/2" cal. B&B

- 16. CONTRACTOR SHALL MAINTAIN THE INTEGRITY OF THE EXISTING DRAINAGE SYSTEM AT ALL TIMES. WHEN IT IS NECESSARY TO INTERRUPT THE EXISTING DRAINAGE PATTERNS AND/OR UTILITIES, PROVIDE TEMPORARY FACILITIES UNTIL WORK IS PERMANENTLY STABILIZED AND APPROVED BY DIRECTOR'S REPRESENTATIVE.
- 17. THE SIDES OF ANY NEW CUT AND/OR FILL SLOPES SHALL BE CONSTRUCTED W/ITH SLOPES NO STEEPER THAN 1 FOOT (VERTICAL) OVER 2 FOOT (HORIZONTAL).

COMMON NAME

Red Maple

## PLANT SCHEDULE

DECIDUOUS TREES

SYM. QTY. BOTANICAL NAME

AR 4 Acer rubrum 'Frank's Red'

BN	-	Potula pigra 'Horitago'	Heritage River Birch	2 2 1/2 Gai.	DOD MILITICTEM	SEEDS, OR SIMILAR BLEND OF PERENNIAL RYE
	6	Betula nigra 'Heritage'	Sugar Maple	6'-8' ht.	B&B, MULTI-STEM	FESCUES, KENTUCKY BLUEGRASS AND ANNUA
AS	3	Acer saccharum 'Green Mountain'		2"-2 1/2" cal.	B&B	RYE.
CK	2	Cladrastis kentukea	Yellow Wood	2"-2 1/2" cal.	B&B	<u>WOODLAND RESTORATION:</u> NATIVE RIGHT OF   WAY WOODS MIX WITH ANNUAL RYE' OR 'NATI'
LT	2	Liriodendron tulipifera	Tuliptree	2"-2 1/2" cal.	B&B	STEEP SLOPE MIX WITH ANNUAL RYE' BY ERNS
QB	2	Quercus bicolor	Swamp White Oak	2"-2 1/2" cal.	B&B	SEEDS, OR APPROVED EQUAL.
QP	4	Quercus palustris	Pin Oak	2"-2 1/2" cal.	B&B	STORMWATER MANAGEMENT PONDS:
QR	2	Quercus rubra	Northern Red Oak	2"-2 1/2" cal.	B&B	NATIVE STEEP SLOPE MIX WITH ANNUAL RYE'
ORNAME	ENTAL TE	REES				ERNST SEEDS, OR APPROVED EQUAL.
AG	7	Amelanchier x grandiflora 'Autumn Brilliance'	Serviceberry	6'-8' ht.	B&B	
		Amelanchier x grandiflora 'Autumn Brilliance'	Serviceberry	2" cal.	B&B	
CF	9	Cornus florida	Dogwood	2" cal.	B&B	
CO	5	Cornus kousa chinensis 'Milky Way'	Milky Way Dogwood	2" cal.	B&B	
CC	11	Cercis canadensis	Eastern Redbud	6'-8' ht.	B&B	
MA	6	Malus 'Adams'	Adams Crabapple	2" cal.	B&B	
PS	5	Prunus serrulata 'Kwanzan'	Kwanzan Cherry	2" cal.	B&B	
EVERGRI	EEN TRI	 ≣ES				
AB	25	Abies balsamea	Balsam Fir	6'-8' ht.	B&B	
PG	24	'Picea glauca	White Spruce	6'-8' ht.	B&B	
JV	25	Juniperus virginiana	Eastern Red Cedar	6'-8' ht.	B&B	
PI	18	Pinus strobus	Eastern White Pine	6'-8' ht.	B&B	
TC	22	Tsuga canadensis	Hemlock	6'-8' ht.	B&B	
		1 Suga Cariaderisis	Петпоск	0-0 III.	DQD	
SHRUBS						
		Buddleia davidii	Butterfly Bush	3 gal.	cont.	
		Ceanothus americanus	New Jersey Tea	3 gal.	cont.	
		Clethra alnifolia 'Hummingbird'	Hummingbird Clethra	3 gal.	cont.	
		Clethra alnifolia 'Ruby Spice'	Ruby Spice Clethra	3 gal.	cont.	
		Cornus alba	Red Twig Dogwood	3 gal.	cont.	
		Fothergilla gardenii	Dwarf Fothergilla	3 gal.	cont.	
		Itea virginica 'Henry's Garnet'	Virginia Sweetspire	3 gal.	cont.	
		Hydrangea paniculata 'Little Lamb'	Little Lamb Hydrangea	3 gal.	cont.	
		Hydrangea paniculata 'Little Quickfire'	Little Quickfire Hydrangea	3 gal.	cont.	
		llex glabra 'Nordic'	Inkberry	3 gal.	cont.	
		llex verticillata 'Red Sprite'	Red Sprite Winterberry	3 gal.	cont.	
		llex verticillata 'Jim Dandy'	Jim Dandy Winterbery	3 gal.	cont.	
		Myrica pensylvanica	Northern Bayberry	3 gal.	cont.	
		Philadelphus x 'Snowbelle'	Snowbelle Mockorange	3 gal.	cont.	
		Physocarpus opulifolius 'Coppertina'	Coppertina Ninebark	3 gal.	cont.	
RC	63	Rhododendron 'Catawbiense'	Purple Rhododendron	7 gal./30"-36" ht.	cont	
RP	38	Rhododendron 'PJM'	PJM Rhododendon	7 gal./30"-36" ht.	cont	
131		Rhododendron 'Roseum Pink'	Rhoseum Pink Rhododendon	5 gal.	cont.	
		Rhododendron 'Scintillation'	Scintillation Rhododendon	5 gal.	cont.	
$\longrightarrow$		Viburnum plicatum tomentosum	Double file Viburnum	5 gal.	cont.	
$\longrightarrow$		'	Compact Cranberrybush		COIIL.	
		Vibrana and tribah and ID ail and a Common att		ا محا		
<del></del>		Viburnum trilobum 'Bailey's Compact'	Viburnum	3 gal.	cont.	
		Viburnum trilobum 'Bailey's Compact' Viburnum carlesii 'Compactum'		3 gal. 3 gal.	cont.	
PERENNI	IALS / GF		Viburnum Compact Koreanspice Viburnum			
PERENNI	IALS / GF	Viburnum carlesii 'Compactum'	Viburnum Compact Koreanspice Viburnum			
PERENNI	IALS / GF	Viburnum carlesii 'Compactum' RASSES / GROUNDCOVERS / HERBA	Viburnum Compact Koreanspice Viburnum ACEOUS	3 gal.	cont.	
PERENN	IALS / GI	Viburnum carlesii 'Compactum'  RASSES / GROUNDCOVERS / HERBA Anemone hupehensis 'September Charm'	Viburnum Compact Koreanspice Viburnum ACEOUS September Charm Anemone	3 gal. 1 gal.	cont.	
PERENN	IALS / GI	Viburnum carlesii 'Compactum'  RASSES / GROUNDCOVERS / HERBA Anemone hupehensis 'September Charm' Arctostaphylos uva-ursi	Viburnum Compact Koreanspice Viburnum ACEOUS September Charm Anemone Bearberry	3 gal. 1 gal. 1 gal. 1 gal.	cont. cont. cont.	
PERENNI	IALS / GI	Viburnum carlesii 'Compactum'  RASSES / GROUNDCOVERS / HERBA Anemone hupehensis 'September Charm' Arctostaphylos uva-ursi Aster novae-angliae Astilbe chinensis 'Vision in White'	Viburnum Compact Koreanspice Viburnum ACEOUS September Charm Anemone Bearberry New England Aster Visons in White Astilbe	3 gal. 1 gal. 1 gal. 1 gal. 1 gal.	cont.  cont.  cont.  cont.  cont.  cont.	
PERENN	IALS / GI	Viburnum carlesii 'Compactum'  RASSES / GROUNDCOVERS / HERBA Anemone hupehensis 'September Charm'  Arctostaphylos uva-ursi Aster novae-angliae  Astilbe chinensis 'Vision in White'  Calamagrostis 'Karl Foerster'	Viburnum Compact Koreanspice Viburnum ACEOUS September Charm Anemone Bearberry New England Aster Visons in White Astilbe Feather Reed Grass	3 gal.  1 gal.  1 gal.  1 gal.  1 gal.  1 gal.  1 gal.	cont.  cont.  cont.  cont.  cont.  cont.  cont.  cont.	
PERENNI	IALS / GI	Viburnum carlesii 'Compactum'  RASSES / GROUNDCOVERS / HERBA Anemone hupehensis 'September Charm' Arctostaphylos uva-ursi Aster novae-angliae Astilbe chinensis 'Vision in White' Calamagrostis 'Karl Foerster' Carex vulpinoidea	Viburnum Compact Koreanspice Viburnum ACEOUS September Charm Anemone Bearberry New England Aster Visons in White Astilbe Feather Reed Grass Fox Sedge	3 gal.  1 gal.	cont.  cont.  cont.  cont.  cont.  cont.  cont.  cont.  cont.	
PERENNI	IALS / GI	Viburnum carlesii 'Compactum'  RASSES / GROUNDCOVERS / HERBA Anemone hupehensis 'September Charm' Arctostaphylos uva-ursi Aster novae-angliae Astilbe chinensis 'Vision in White' Calamagrostis 'Karl Foerster' Carex vulpinoidea Chasmanthium latifolium	Viburnum Compact Koreanspice Viburnum ACEOUS September Charm Anemone Bearberry New England Aster Visons in White Astilbe Feather Reed Grass Fox Sedge Northern Sea Oats	3 gal.  1 gal.	cont.	
PERENN	IALS / GI	Viburnum carlesii 'Compactum'  RASSES / GROUNDCOVERS / HERBA Anemone hupehensis 'September Charm' Arctostaphylos uva-ursi Aster novae-angliae Astilbe chinensis 'Vision in White' Calamagrostis 'Karl Foerster' Carex vulpinoidea Chasmanthium latifolium Chelone obliqua	Viburnum Compact Koreanspice Viburnum ACEOUS September Charm Anemone Bearberry New England Aster Visons in White Astilbe Feather Reed Grass Fox Sedge Northern Sea Oats Pink Turtlehead	3 gal.  1 gal.	cont.	
PERENN	IALS / GI	Viburnum carlesii 'Compactum'  RASSES / GROUNDCOVERS / HERBA Anemone hupehensis 'September Charm' Arctostaphylos uva-ursi Aster novae-angliae Astilbe chinensis 'Vision in White' Calamagrostis 'Karl Foerster' Carex vulpinoidea Chasmanthium latifolium Chelone obliqua Dennstaedia punctiloba	Viburnum Compact Koreanspice Viburnum ACEOUS September Charm Anemone Bearberry New England Aster Visons in White Astilbe Feather Reed Grass Fox Sedge Northern Sea Oats Pink Turtlehead Hay-scented fern	3 gal.  1 gal.	cont.	
PERENNI	IALS / GI	Viburnum carlesii 'Compactum'  RASSES / GROUNDCOVERS / HERBA Anemone hupehensis 'September Charm' Arctostaphylos uva-ursi Aster novae-angliae Astilbe chinensis 'Vision in White' Calamagrostis 'Karl Foerster' Carex vulpinoidea Chasmanthium latifolium Chelone obliqua Dennstaedia punctiloba Dicentra spectabilis	Viburnum Compact Koreanspice Viburnum ACEOUS September Charm Anemone Bearberry New England Aster Visons in White Astilbe Feather Reed Grass Fox Sedge Northern Sea Oats Pink Turtlehead Hay-scented fern Common Bleeding Heart	3 gal.  1 gal.	cont.	
PERENN	IALS / GI	Viburnum carlesii 'Compactum'  RASSES / GROUNDCOVERS / HERBA Anemone hupehensis 'September Charm' Arctostaphylos uva-ursi Aster novae-angliae Astilbe chinensis 'Vision in White' Calamagrostis 'Karl Foerster' Carex vulpinoidea Chasmanthium latifolium Chelone obliqua Dennstaedia punctiloba Dicentra spectabilis Echinacea purpurea 'Magnus'	Viburnum Compact Koreanspice Viburnum ACEOUS September Charm Anemone Bearberry New England Aster Visons in White Astilbe Feather Reed Grass Fox Sedge Northern Sea Oats Pink Turtlehead Hay-scented fern Common Bleeding Heart Purple Coneflower	3 gal.  1 gal.	cont.	
PERENN	IALS / GI	Viburnum carlesii 'Compactum'  RASSES / GROUNDCOVERS / HERBA Anemone hupehensis 'September Charm' Arctostaphylos uva-ursi Aster novae-angliae Astilbe chinensis 'Vision in White' Calamagrostis 'Karl Foerster' Carex vulpinoidea Chasmanthium latifolium Chelone obliqua Dennstaedia punctiloba Dicentra spectabilis Echinacea purpurea 'Magnus' Filix-femina	Viburnum Compact Koreanspice Viburnum ACEOUS September Charm Anemone Bearberry New England Aster Visons in White Astilbe Feather Reed Grass Fox Sedge Northern Sea Oats Pink Turtlehead Hay-scented fern Common Bleeding Heart Purple Coneflower lady Fern	3 gal.  1 gal.	cont.	
PERENN	IALS / GI	Viburnum carlesii 'Compactum'  RASSES / GROUNDCOVERS / HERBA Anemone hupehensis 'September Charm' Arctostaphylos uva-ursi Aster novae-angliae Astilbe chinensis 'Vision in White' Calamagrostis 'Karl Foerster' Carex vulpinoidea Chasmanthium latifolium Chelone obliqua Dennstaedia punctiloba Dicentra spectabilis Echinacea purpurea 'Magnus' Filix-femina Hemerocallis	Viburnum Compact Koreanspice Viburnum ACEOUS September Charm Anemone Bearberry New England Aster Visons in White Astilbe Feather Reed Grass Fox Sedge Northern Sea Oats Pink Turtlehead Hay-scented fern Common Bleeding Heart Purple Coneflower lady Fern Daylilies	3 gal.  1 gal.	cont.	
PERENN	IALS / GI	Viburnum carlesii 'Compactum'  RASSES / GROUNDCOVERS / HERBA Anemone hupehensis 'September Charm' Arctostaphylos uva-ursi Aster novae-angliae Astilbe chinensis 'Vision in White' Calamagrostis 'Karl Foerster' Carex vulpinoidea Chasmanthium latifolium Chelone obliqua Dennstaedia punctiloba Dicentra spectabilis Echinacea purpurea 'Magnus' Filix-femina Hemerocallis Hosta 'Gold Standard'	Viburnum Compact Koreanspice Viburnum ACEOUS September Charm Anemone Bearberry New England Aster Visons in White Astilbe Feather Reed Grass Fox Sedge Northern Sea Oats Pink Turtlehead Hay-scented fern Common Bleeding Heart Purple Coneflower lady Fern Daylilies Gold Standard Hosta	3 gal.  1 gal.	cont.	
PERENN	IALS / GI	Viburnum carlesii 'Compactum'  RASSES / GROUNDCOVERS / HERBA Anemone hupehensis 'September Charm' Arctostaphylos uva-ursi Aster novae-angliae Astilbe chinensis 'Vision in White' Calamagrostis 'Karl Foerster' Carex vulpinoidea Chasmanthium latifolium Chelone obliqua Dennstaedia punctiloba Dicentra spectabilis Echinacea purpurea 'Magnus' Filix-femina Hemerocallis Hosta 'Gold Standard' Lobelia cardinalis	Viburnum Compact Koreanspice Viburnum ACEOUS September Charm Anemone Bearberry New England Aster Visons in White Astilbe Feather Reed Grass Fox Sedge Northern Sea Oats Pink Turtlehead Hay-scented fern Common Bleeding Heart Purple Coneflower lady Fern Daylilies Gold Standard Hosta Cardinal Flower	3 gal.  1 gal.	cont.	
PERENN	IALS / GI	Viburnum carlesii 'Compactum'  RASSES / GROUNDCOVERS / HERBA Anemone hupehensis 'September Charm' Arctostaphylos uva-ursi Aster novae-angliae Astilbe chinensis 'Vision in White' Calamagrostis 'Karl Foerster' Carex vulpinoidea Chasmanthium latifolium Chelone obliqua Dennstaedia punctiloba Dicentra spectabilis Echinacea purpurea 'Magnus' Filix-femina Hemerocallis Hosta 'Gold Standard' Lobelia cardinalis Monarda didyma	Viburnum Compact Koreanspice Viburnum ACEOUS September Charm Anemone Bearberry New England Aster Visons in White Astilbe Feather Reed Grass Fox Sedge Northern Sea Oats Pink Turtlehead Hay-scented fern Common Bleeding Heart Purple Coneflower lady Fern Daylilies Gold Standard Hosta Cardinal Flower Beebalm	3 gal.  1 gal.	cont.	
PERENN	IALS / GI	Viburnum carlesii 'Compactum'  RASSES / GROUNDCOVERS / HERBA Anemone hupehensis 'September Charm' Arctostaphylos uva-ursi Aster novae-angliae Astilbe chinensis 'Vision in White' Calamagrostis 'Karl Foerster' Carex vulpinoidea Chasmanthium latifolium Chelone obliqua Dennstaedia punctiloba Dicentra spectabilis Echinacea purpurea 'Magnus' Filix-femina Hemerocallis Hosta 'Gold Standard' Lobelia cardinalis Monarda didyma Osmunda cinnamomea	Viburnum Compact Koreanspice Viburnum ACEOUS September Charm Anemone Bearberry New England Aster Visons in White Astilbe Feather Reed Grass Fox Sedge Northern Sea Oats Pink Turtlehead Hay-scented fern Common Bleeding Heart Purple Coneflower lady Fern Daylilies Gold Standard Hosta Cardinal Flower Beebalm Cinnamon Fern	3 gal.  1 gal.	cont.	
PERENN	IALS / GI	Viburnum carlesii 'Compactum'  RASSES / GROUNDCOVERS / HERBA Anemone hupehensis 'September Charm' Arctostaphylos uva-ursi Aster novae-angliae Astilbe chinensis 'Vision in White' Calamagrostis 'Karl Foerster' Carex vulpinoidea Chasmanthium latifolium Chelone obliqua Dennstaedia punctiloba Dicentra spectabilis Echinacea purpurea 'Magnus' Filix-femina Hemerocallis Hosta 'Gold Standard' Lobelia cardinalis Monarda didyma Osmunda regalis	Viburnum Compact Koreanspice Viburnum ACEOUS September Charm Anemone Bearberry New England Aster Visons in White Astilbe Feather Reed Grass Fox Sedge Northern Sea Oats Pink Turtlehead Hay-scented fern Common Bleeding Heart Purple Coneflower lady Fern Daylilies Gold Standard Hosta Cardinal Flower Beebalm Cinnamon Fern Royal Fern	3 gal.  1 gal.	cont.	
PERENN	IALS / GI	Viburnum carlesii 'Compactum'  RASSES / GROUNDCOVERS / HERBA Anemone hupehensis 'September Charm' Arctostaphylos uva-ursi Aster novae-angliae Astilbe chinensis 'Vision in White' Calamagrostis 'Karl Foerster' Carex vulpinoidea Chasmanthium latifolium Chelone obliqua Dennstaedia punctiloba Dicentra spectabilis Echinacea purpurea 'Magnus' Filix-femina Hemerocallis Hosta 'Gold Standard' Lobelia cardinalis Monarda didyma Osmunda regalis Panicum virgatum 'Shenandoah'	Viburnum Compact Koreanspice Viburnum ACEOUS September Charm Anemone Bearberry New England Aster Visons in White Astilbe Feather Reed Grass Fox Sedge Northern Sea Oats Pink Turtlehead Hay-scented fern Common Bleeding Heart Purple Coneflower lady Fern Daylilies Gold Standard Hosta Cardinal Flower Beebalm Cinnamon Fern Royal Fern Red Switch Grass	3 gal.  1 gal.	cont.	
PERENN	IALS / GI	Viburnum carlesii 'Compactum'  RASSES / GROUNDCOVERS / HERBA Anemone hupehensis 'September Charm' Arctostaphylos uva-ursi Aster novae-angliae Astilbe chinensis 'Vision in White' Calamagrostis 'Karl Foerster' Carex vulpinoidea Chasmanthium latifolium Chelone obliqua Dennstaedia punctiloba Dicentra spectabilis Echinacea purpurea 'Magnus' Filix-femina Hemerocallis Hosta 'Gold Standard' Lobelia cardinalis Monarda didyma Osmunda cinnamomea Osmunda regalis Panicum virgatum 'Shenandoah' Rudbeckia fulgida 'Goldsturm'	Viburnum Compact Koreanspice Viburnum ACEOUS September Charm Anemone Bearberry New England Aster Visons in White Astilbe Feather Reed Grass Fox Sedge Northern Sea Oats Pink Turtlehead Hay-scented fern Common Bleeding Heart Purple Coneflower lady Fern Daylilies Gold Standard Hosta Cardinal Flower Beebalm Cinnamon Fern Royal Fern Red Switch Grass Black-Eyed Susan	3 gal.  1 gal.	cont.	
PERENN	IALS / GI	Viburnum carlesii 'Compactum'  RASSES / GROUNDCOVERS / HERBA Anemone hupehensis 'September Charm' Arctostaphylos uva-ursi Aster novae-angliae Astilbe chinensis 'Vision in White' Calamagrostis 'Karl Foerster' Carex vulpinoidea Chasmanthium latifolium Chelone obliqua Dennstaedia punctiloba Dicentra spectabilis Echinacea purpurea 'Magnus' Filix-femina Hemerocallis Hosta 'Gold Standard' Lobelia cardinalis Monarda didyma Osmunda regalis Panicum virgatum 'Shenandoah'	Viburnum Compact Koreanspice Viburnum ACEOUS September Charm Anemone Bearberry New England Aster Visons in White Astilbe Feather Reed Grass Fox Sedge Northern Sea Oats Pink Turtlehead Hay-scented fern Common Bleeding Heart Purple Coneflower lady Fern Daylilies Gold Standard Hosta Cardinal Flower Beebalm Cinnamon Fern Royal Fern Red Switch Grass	3 gal.  1 gal.	cont.  cont.	

PLAN FOR PROJECT

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People. Purpose. Place

New York State Education Law.

Prepared for:

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550 N 31st Street Billings, MT 59101

Civil Engineer: C.T. Male Associates 50 Century Hill Drive Latham, NY 12110

Architect: **DGC Architects** 40 Church Street, Studio A Ellsworth, ME 04605

Traffic Engineer 80 Wolf Road, Suite 300 Albany, NY 12205

Surveyor: Ausfeld & Waldruff 323 Clinton Street Schenectady, NY 12305

Project Title:

Terramor Catskills

NY ROUTE 212

ISSUED FOR:

Saugerties, NY 12477


SITE PLAN APPLICATION

BAS Ch'k'd: 08/01/2022 Scale:

Description: ⚠ | Review Comments 8/1/22

Drawing Title **NOTES** 

Drawing No.

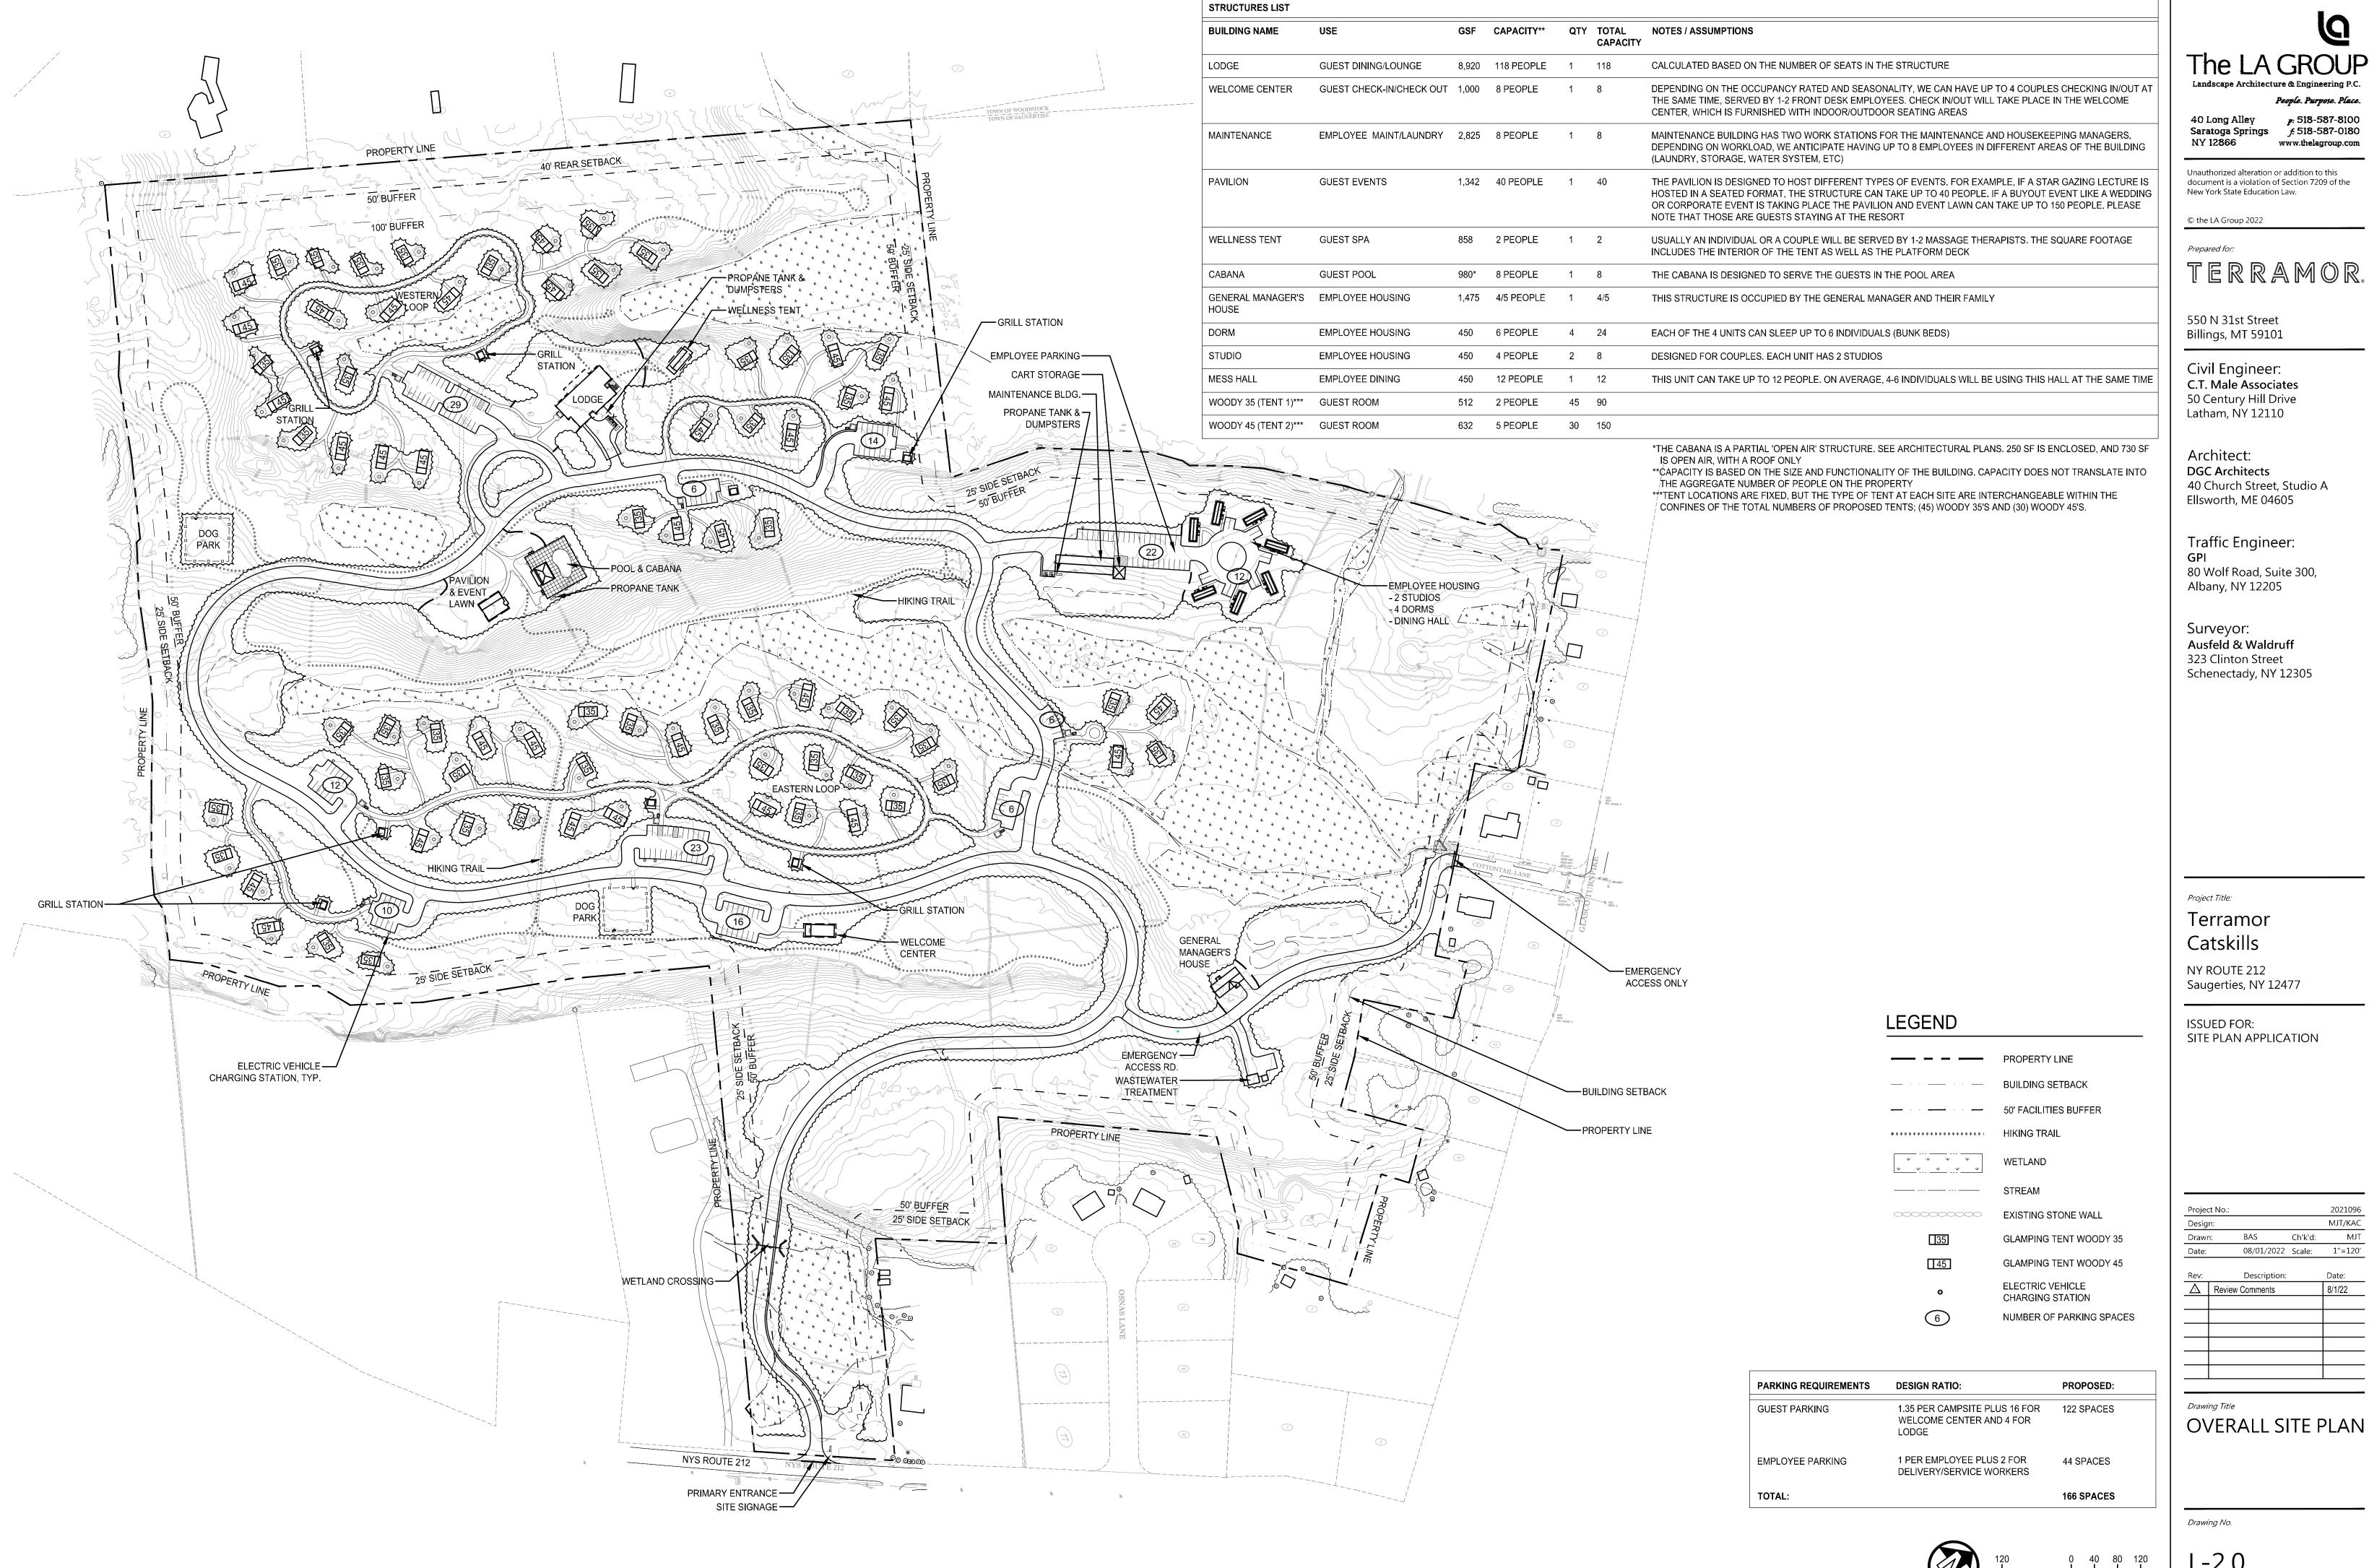

L-2.0





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Architect: DGC Architects 40 Church Street, Studio A Ellsworth, ME 04605

Traffic Engineer: 80 Wolf Road, Suite 300, Albany, NY 12205

Surveyor: Ausfeld & Waldruff 323 Clinton Street Schenectady, NY 12305

Project Title:

# Terramor Catskills

NY ROUTE 212 Saugerties, NY 12477

ISSUED FOR: SITE PLAN APPLICATION

Project No.:			2021096
Design:			MJT/KAC
Drawn:	BAS	Ch'k'd:	MJT
Datas	09/01/2022	Caalar	1"-120'


<b>v</b> :	Description:	Date:
7	Review Comments	8/1/22

Drawing Title

**OVERALL SITE** ACCESS AND CLEARING

Drawing No.

L-3.0

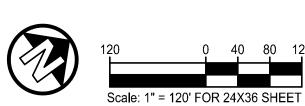

NOTE:
INSTALL ALL EROSION AND SEDIMENT CONTROL

DEVICES PRIOR TO SITE DISTURBANCE. REFER TO SHEETS L-3.1 - L3.9 FOR EROSION AND SEDIMENT CONTROL INFORMATION.

PROPERTY LINE

TREE CLEARING

PROPOSED TREELINE

EXISTING TREELINE


EXISTING STONE WALL


SELECTIVE TREE CLEARING

LEGEND


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Plotted By: BRIDGET A. SNOVER



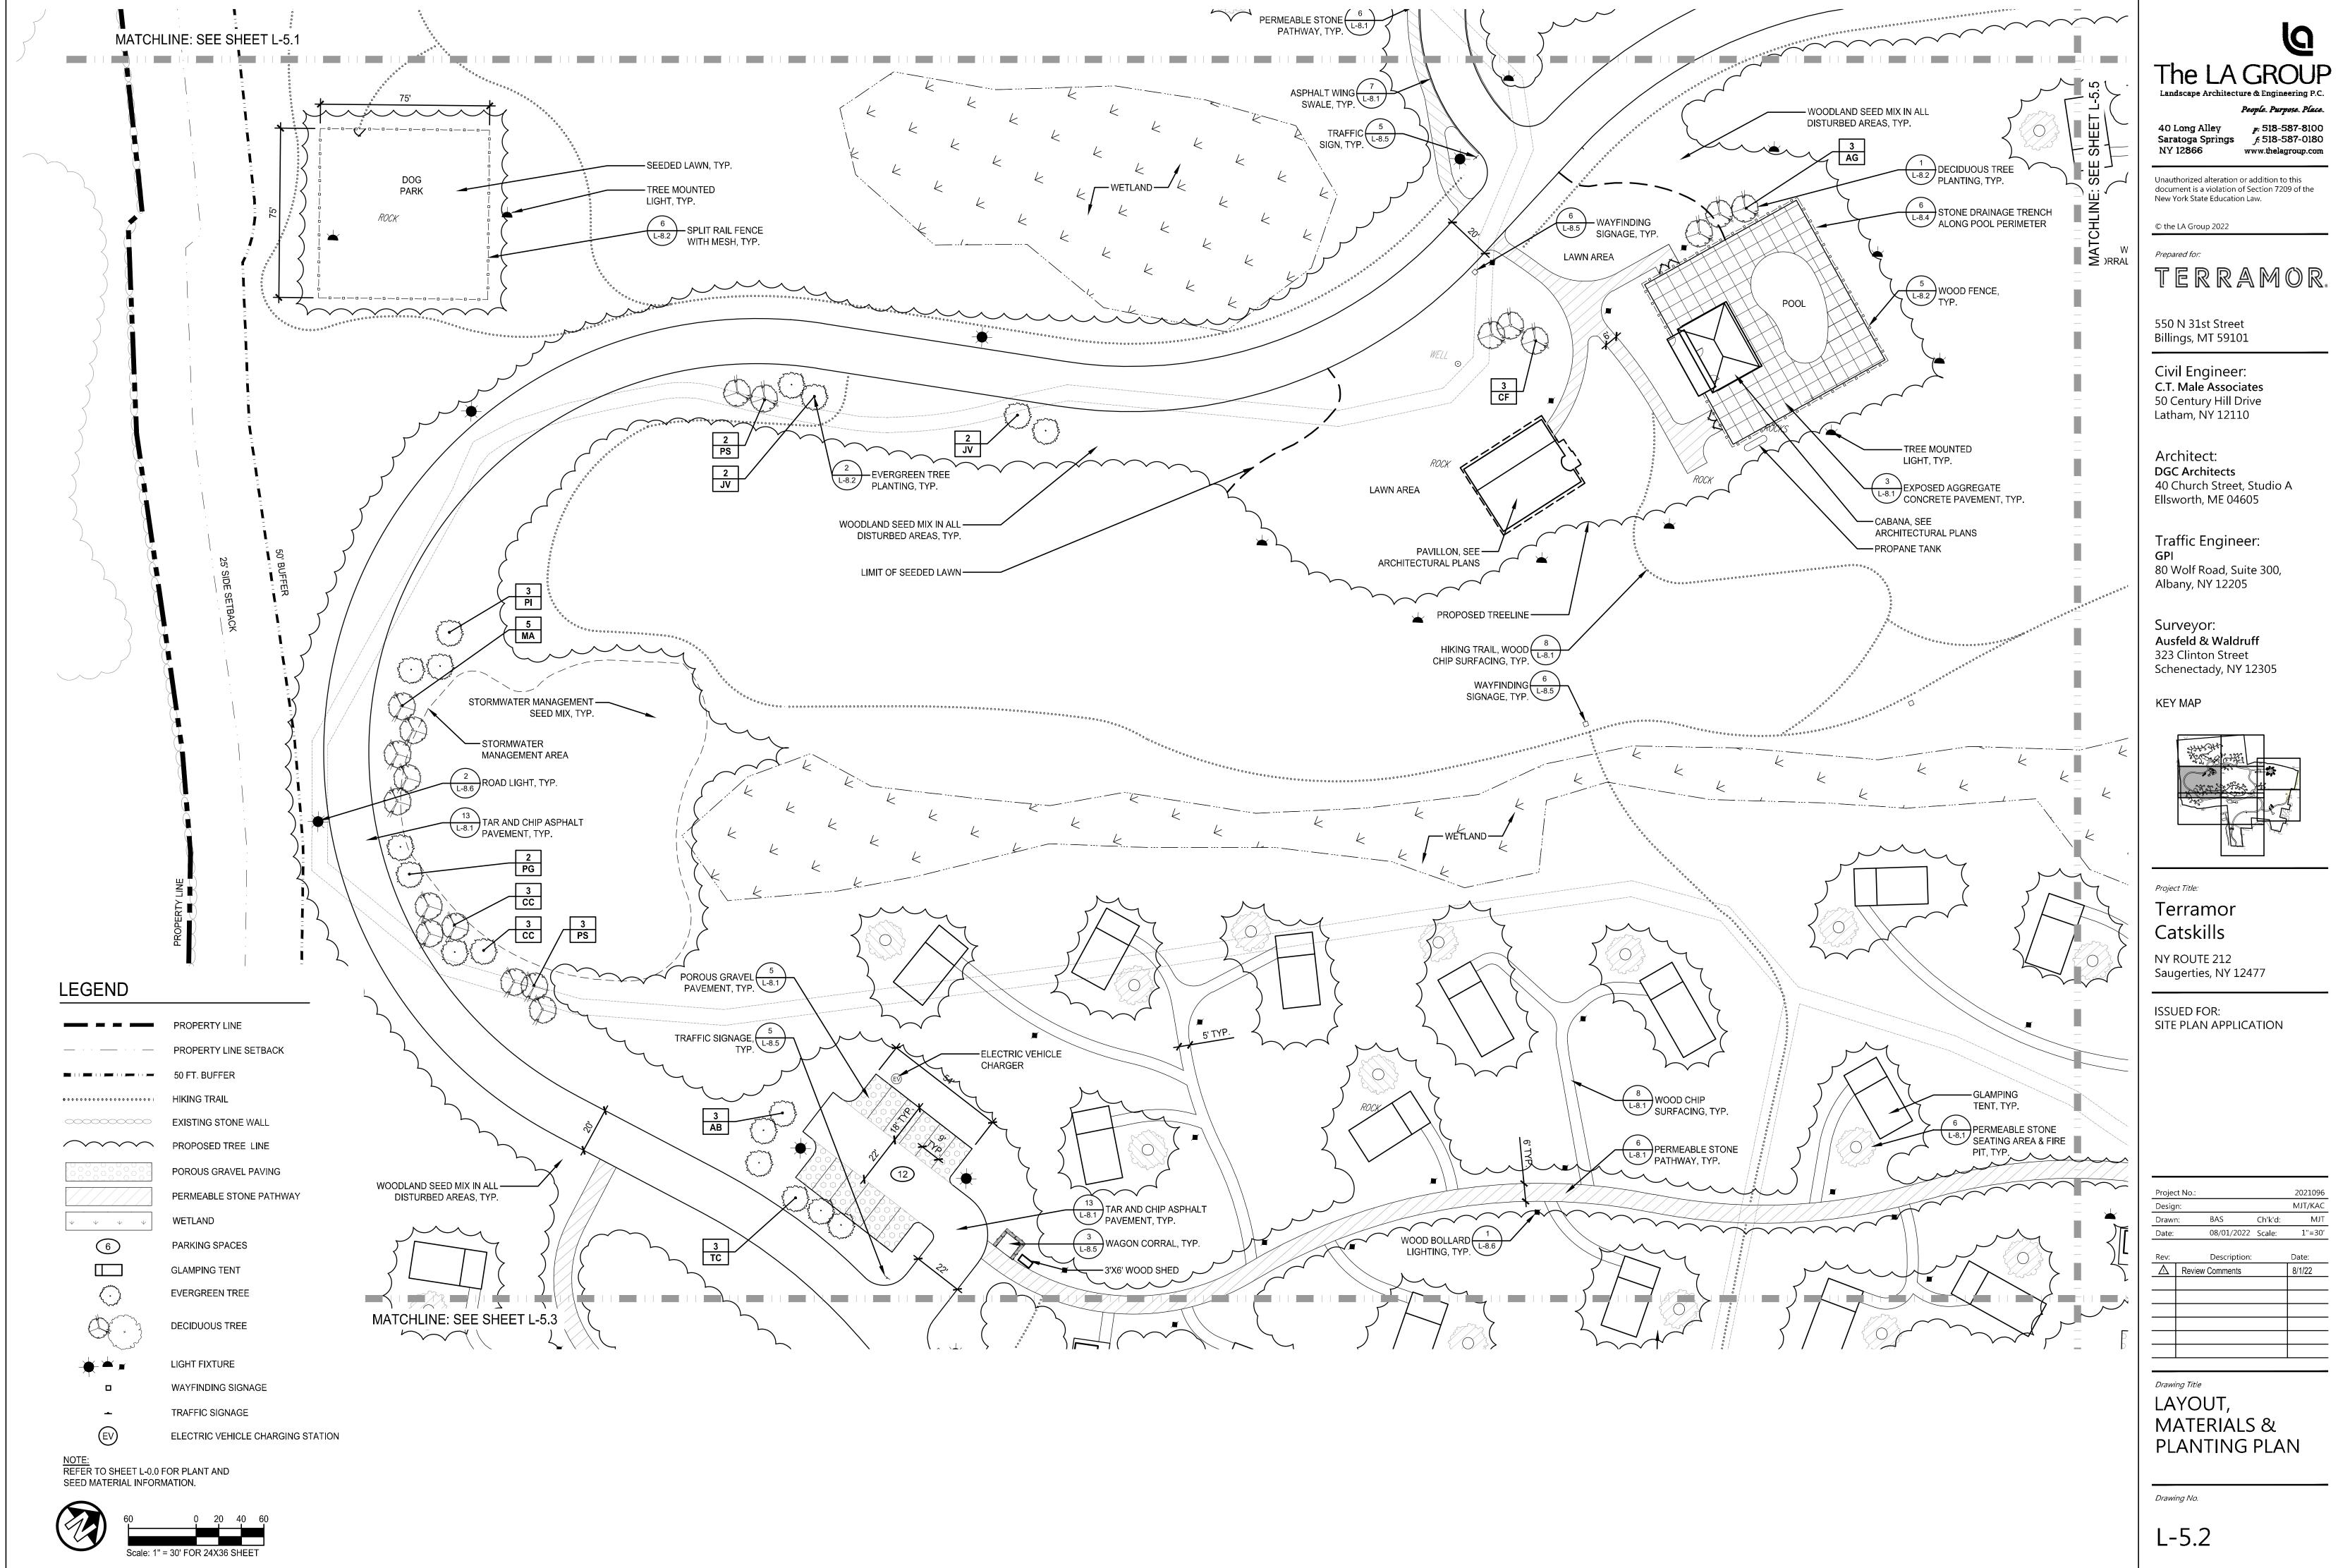
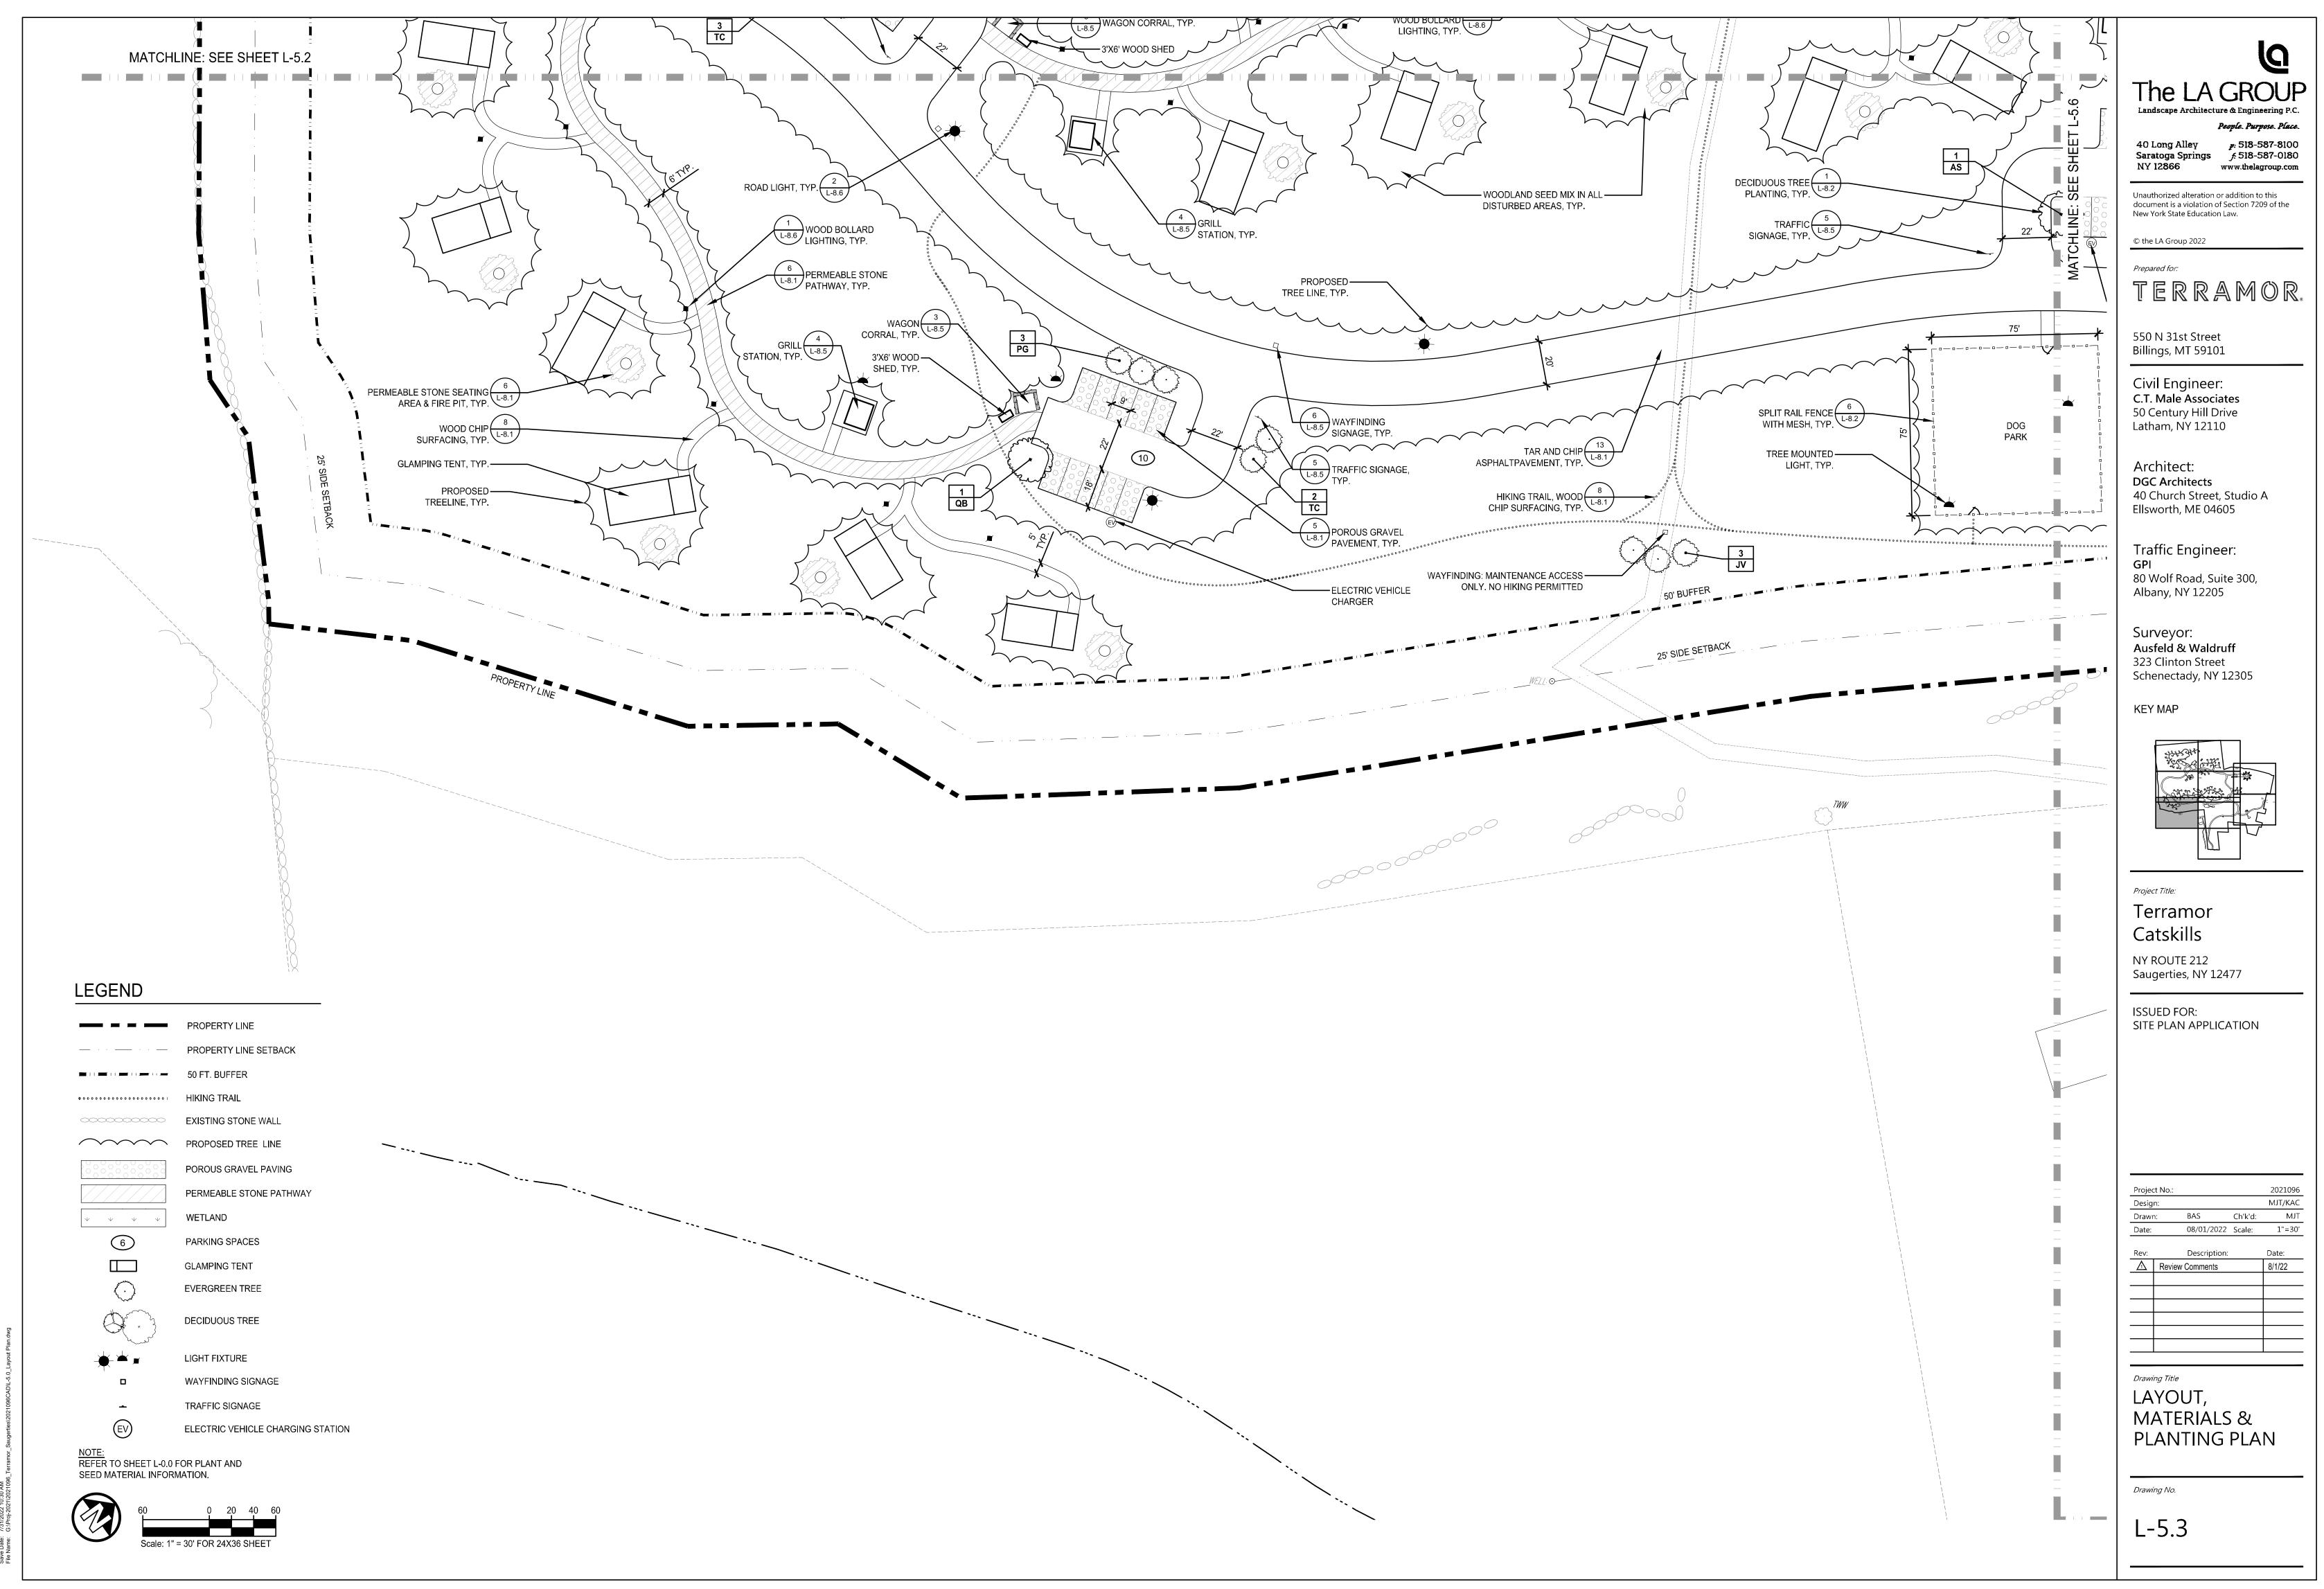
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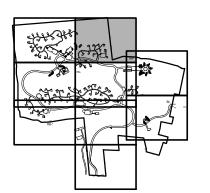
Civil Engineer: C.T. Male Associates

50 Century Hill Drive Latham, NY 12110
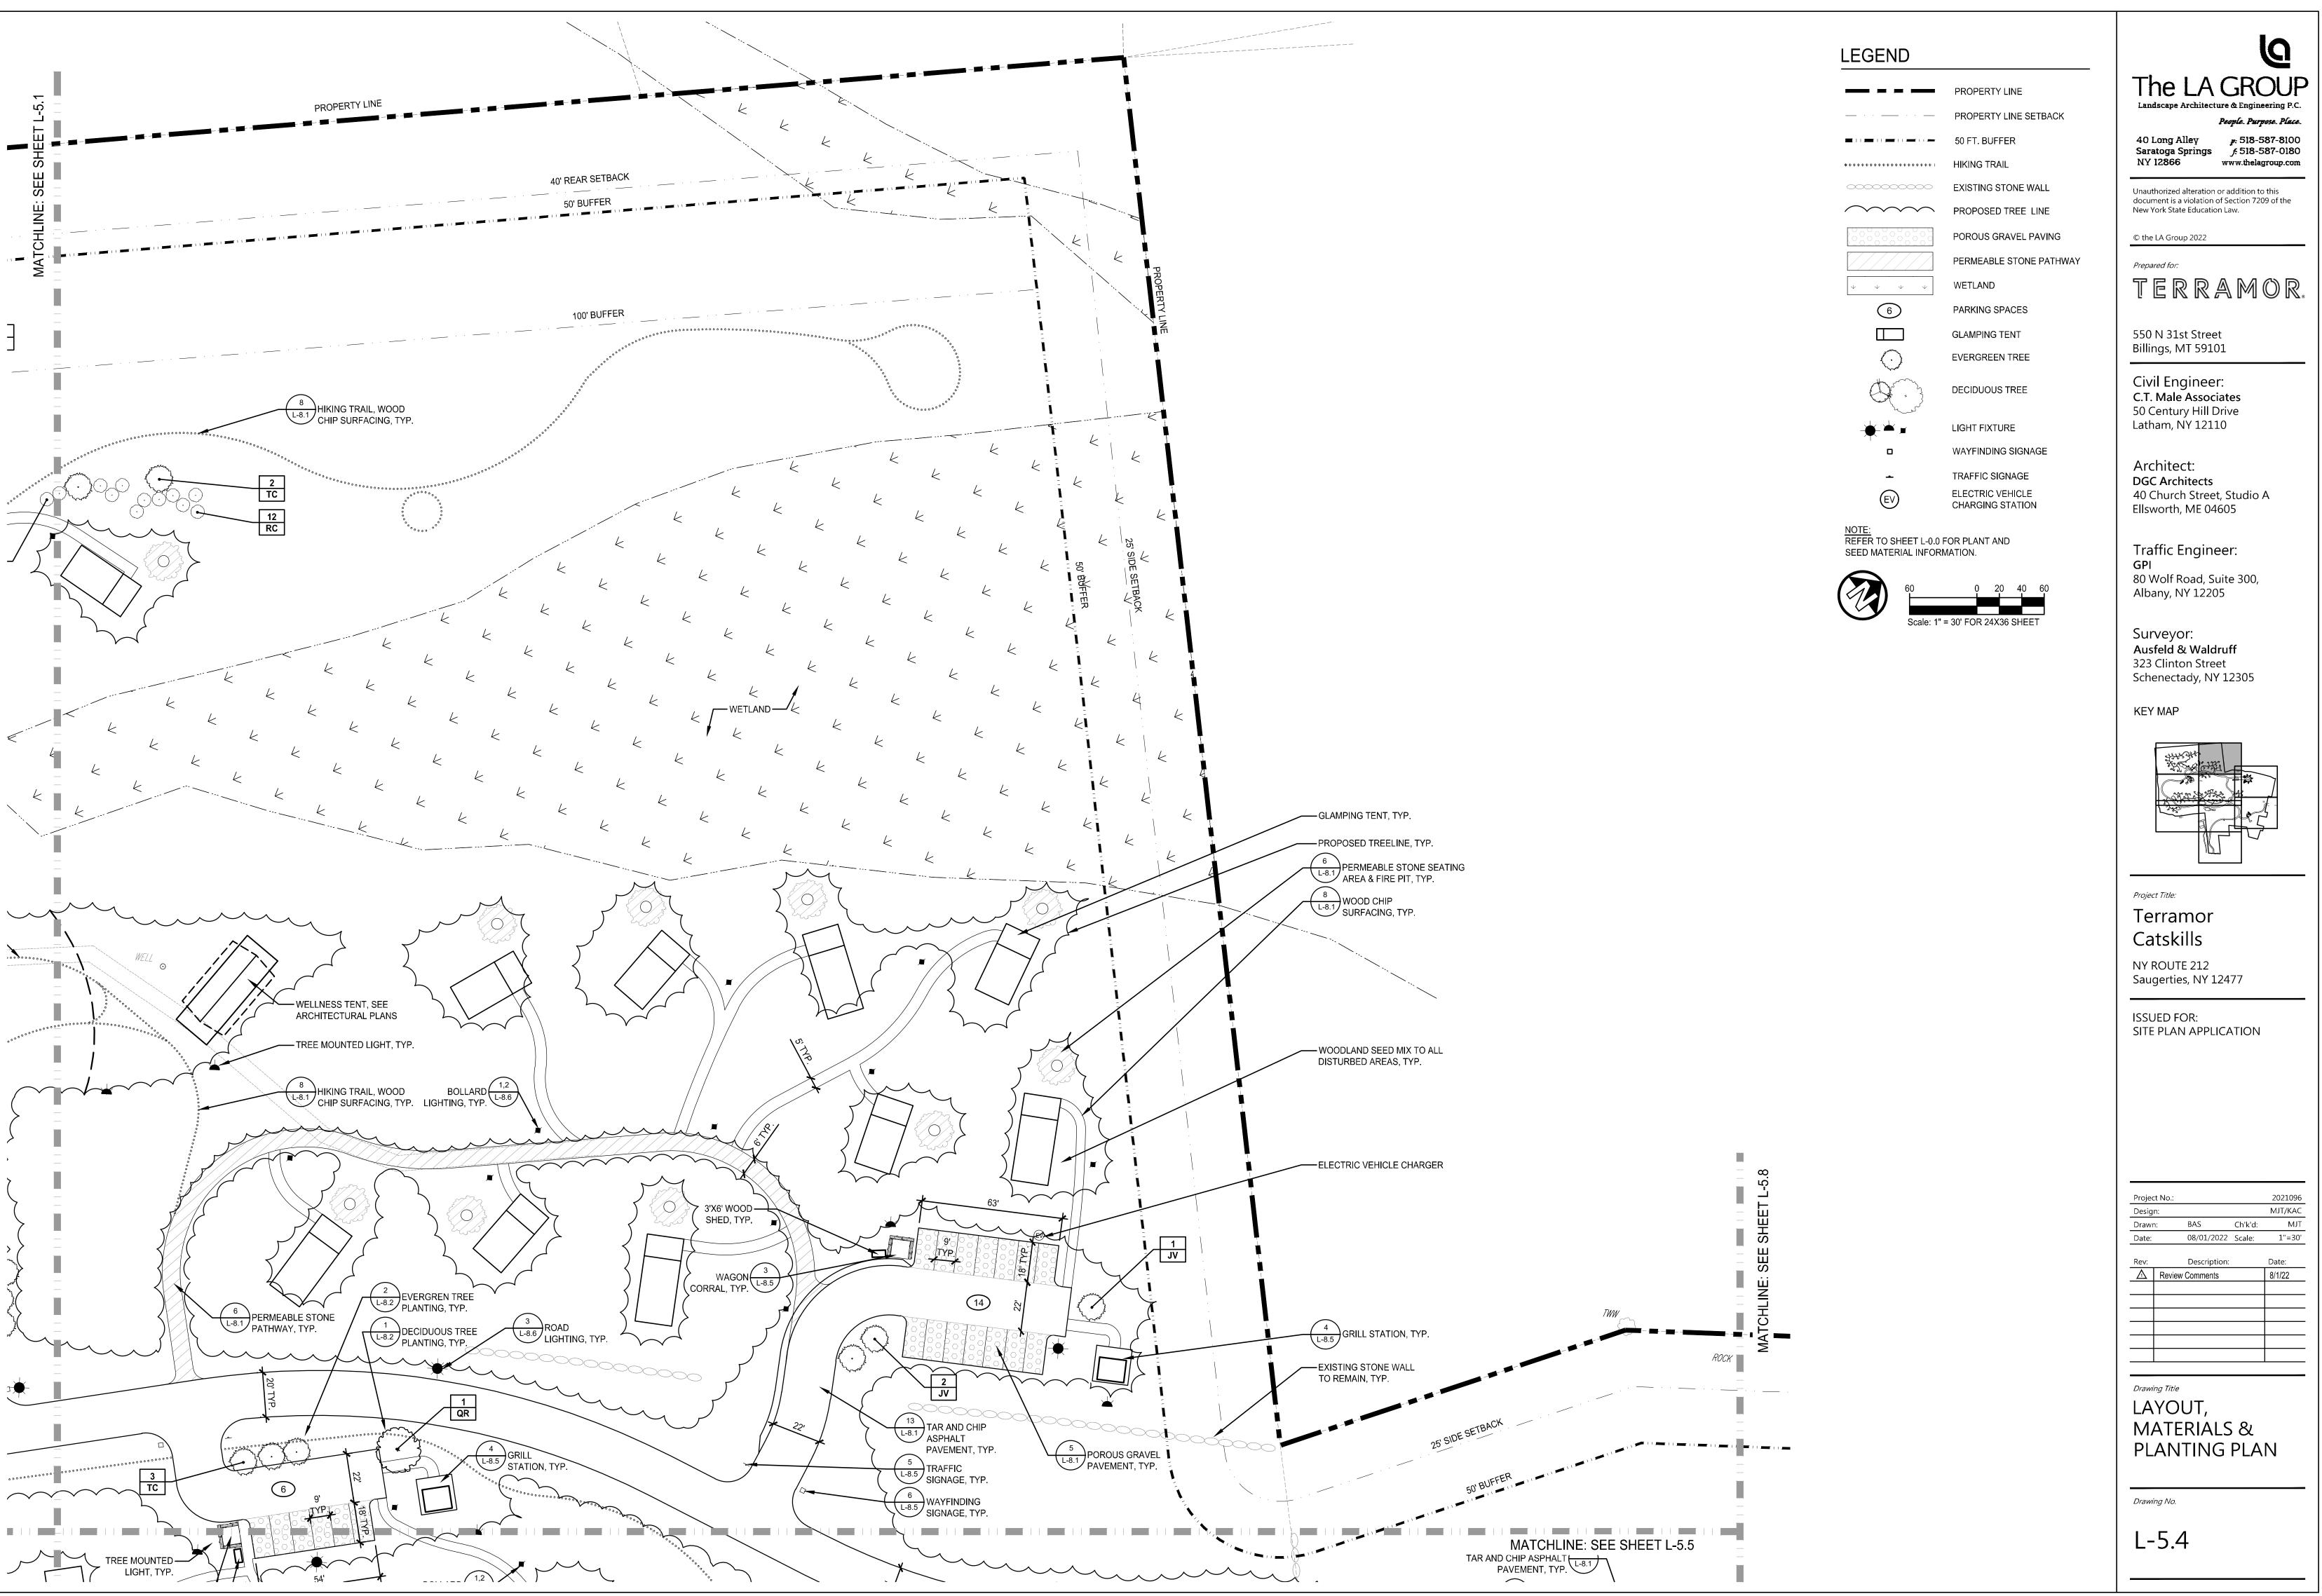
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# Terramor


NY ROUTE 212 Saugerties, NY 12477

SITE PLAN APPLICATION

Project No.:			2021096
Design:	MJT/KAC		
Drawn:	BAS	Ch'k'd:	MJT
Date:	08/01/2022	Scale:	1"=30'
Rev <sup>.</sup>	Description:		Date <sup>.</sup>

A Review Comments

MATERIALS & PLANTING PLAN

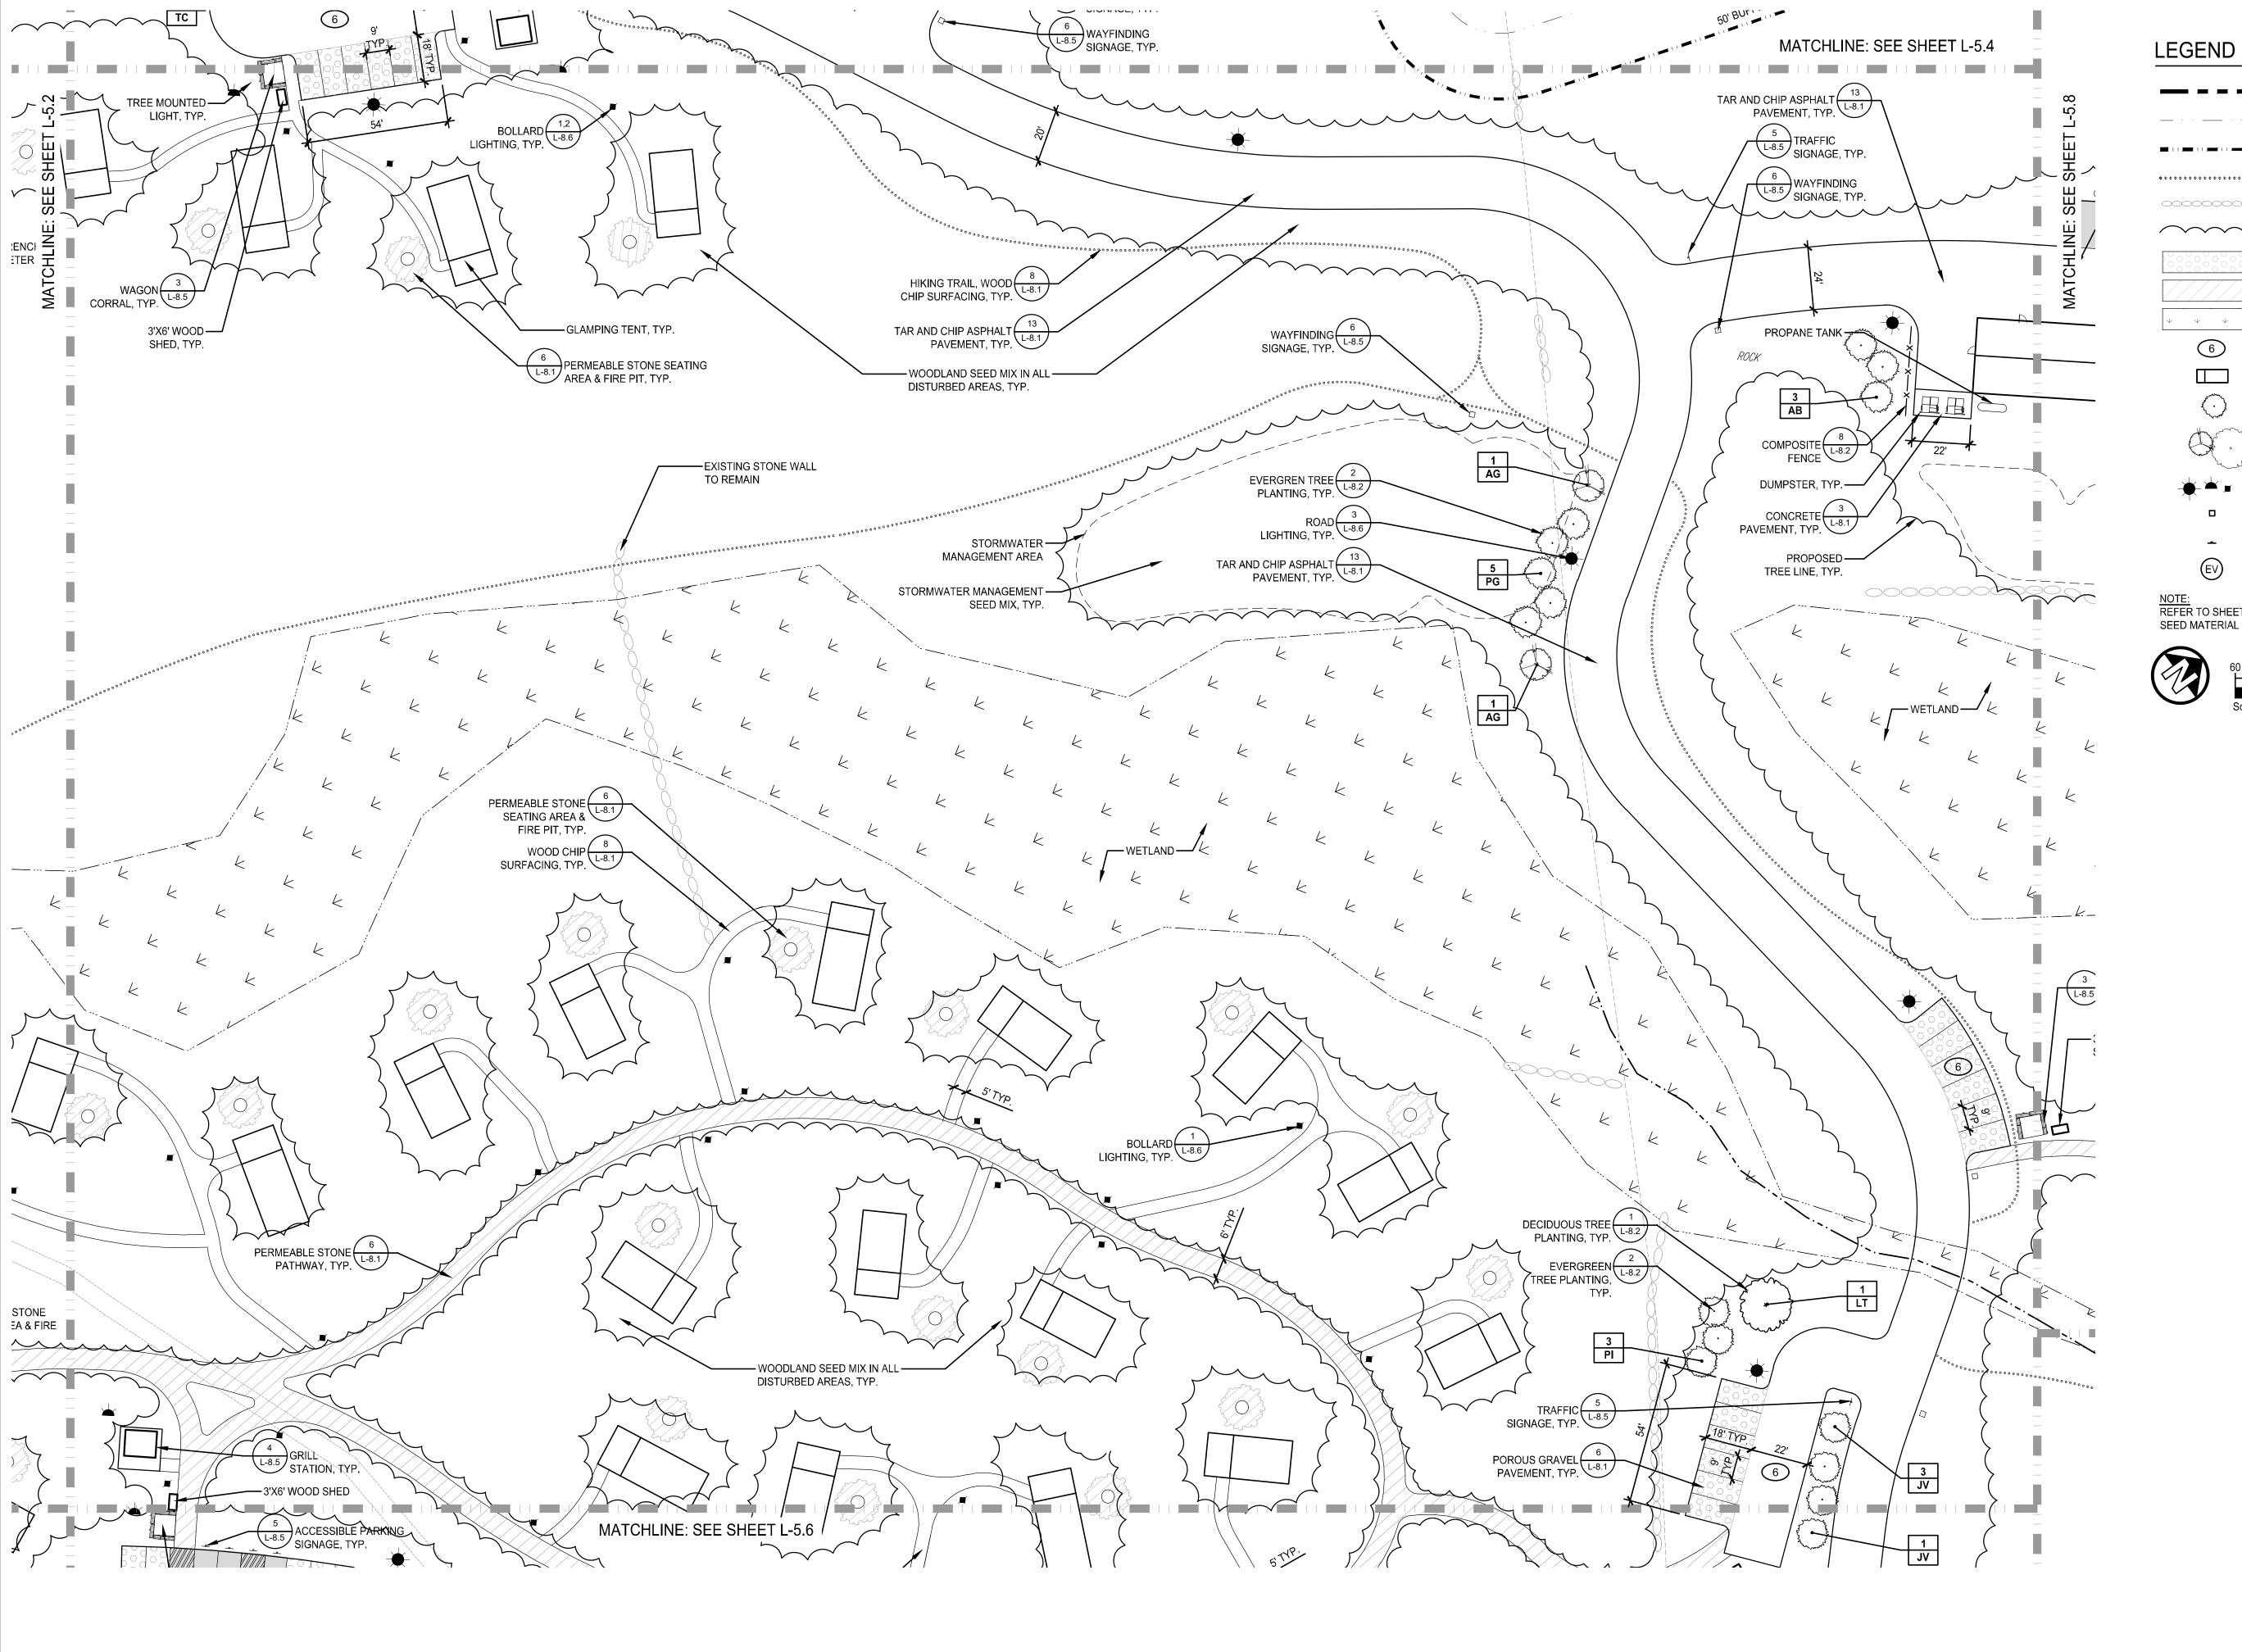

PROPERTY LINE PROPERTY LINE SETBACK 50 FT. BUFFER

EXISTING STONE WALL

PROPOSED TREE LINE POROUS GRAVEL PAVING

PERMEABLE STONE PATHWAY WETLAND 6 PARKING SPACES

**GLAMPING TENT EVERGREEN TREE** 


DECIDUOUS TREE

LIGHT FIXTURE WAYFINDING SIGNAGE

TRAFFIC SIGNAGE ELECTRIC VEHICLE CHARGING STATION

NOTE: REFER TO SHEET L-0.0 FOR PLANT AND SEED MATERIAL INFORMATION.



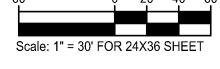

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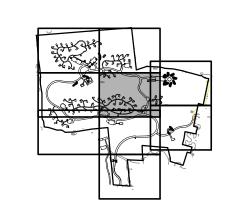
Civil Engineer: C.T. Male Associates 50 Century Hill Drive Latham, NY 12110

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Traffic Engineer: 80 Wolf Road, Suite 300, Albany, NY 12205

Surveyor: Ausfeld & Waldruff 323 Clinton Street Schenectady, NY 12305

**KEY MAP** 



Project Title:

Terramor Catskills

NY ROUTE 212 Saugerties, NY 12477

ISSUED FOR: SITE PLAN APPLICATION


BAS Ch'k'd: MJT 08/01/2022 Scale: 1"=30'

A Review Comments 8/1/22

Drawing Title

LAYOUT, MATERIALS & PLANTING PLAN

Drawing No.

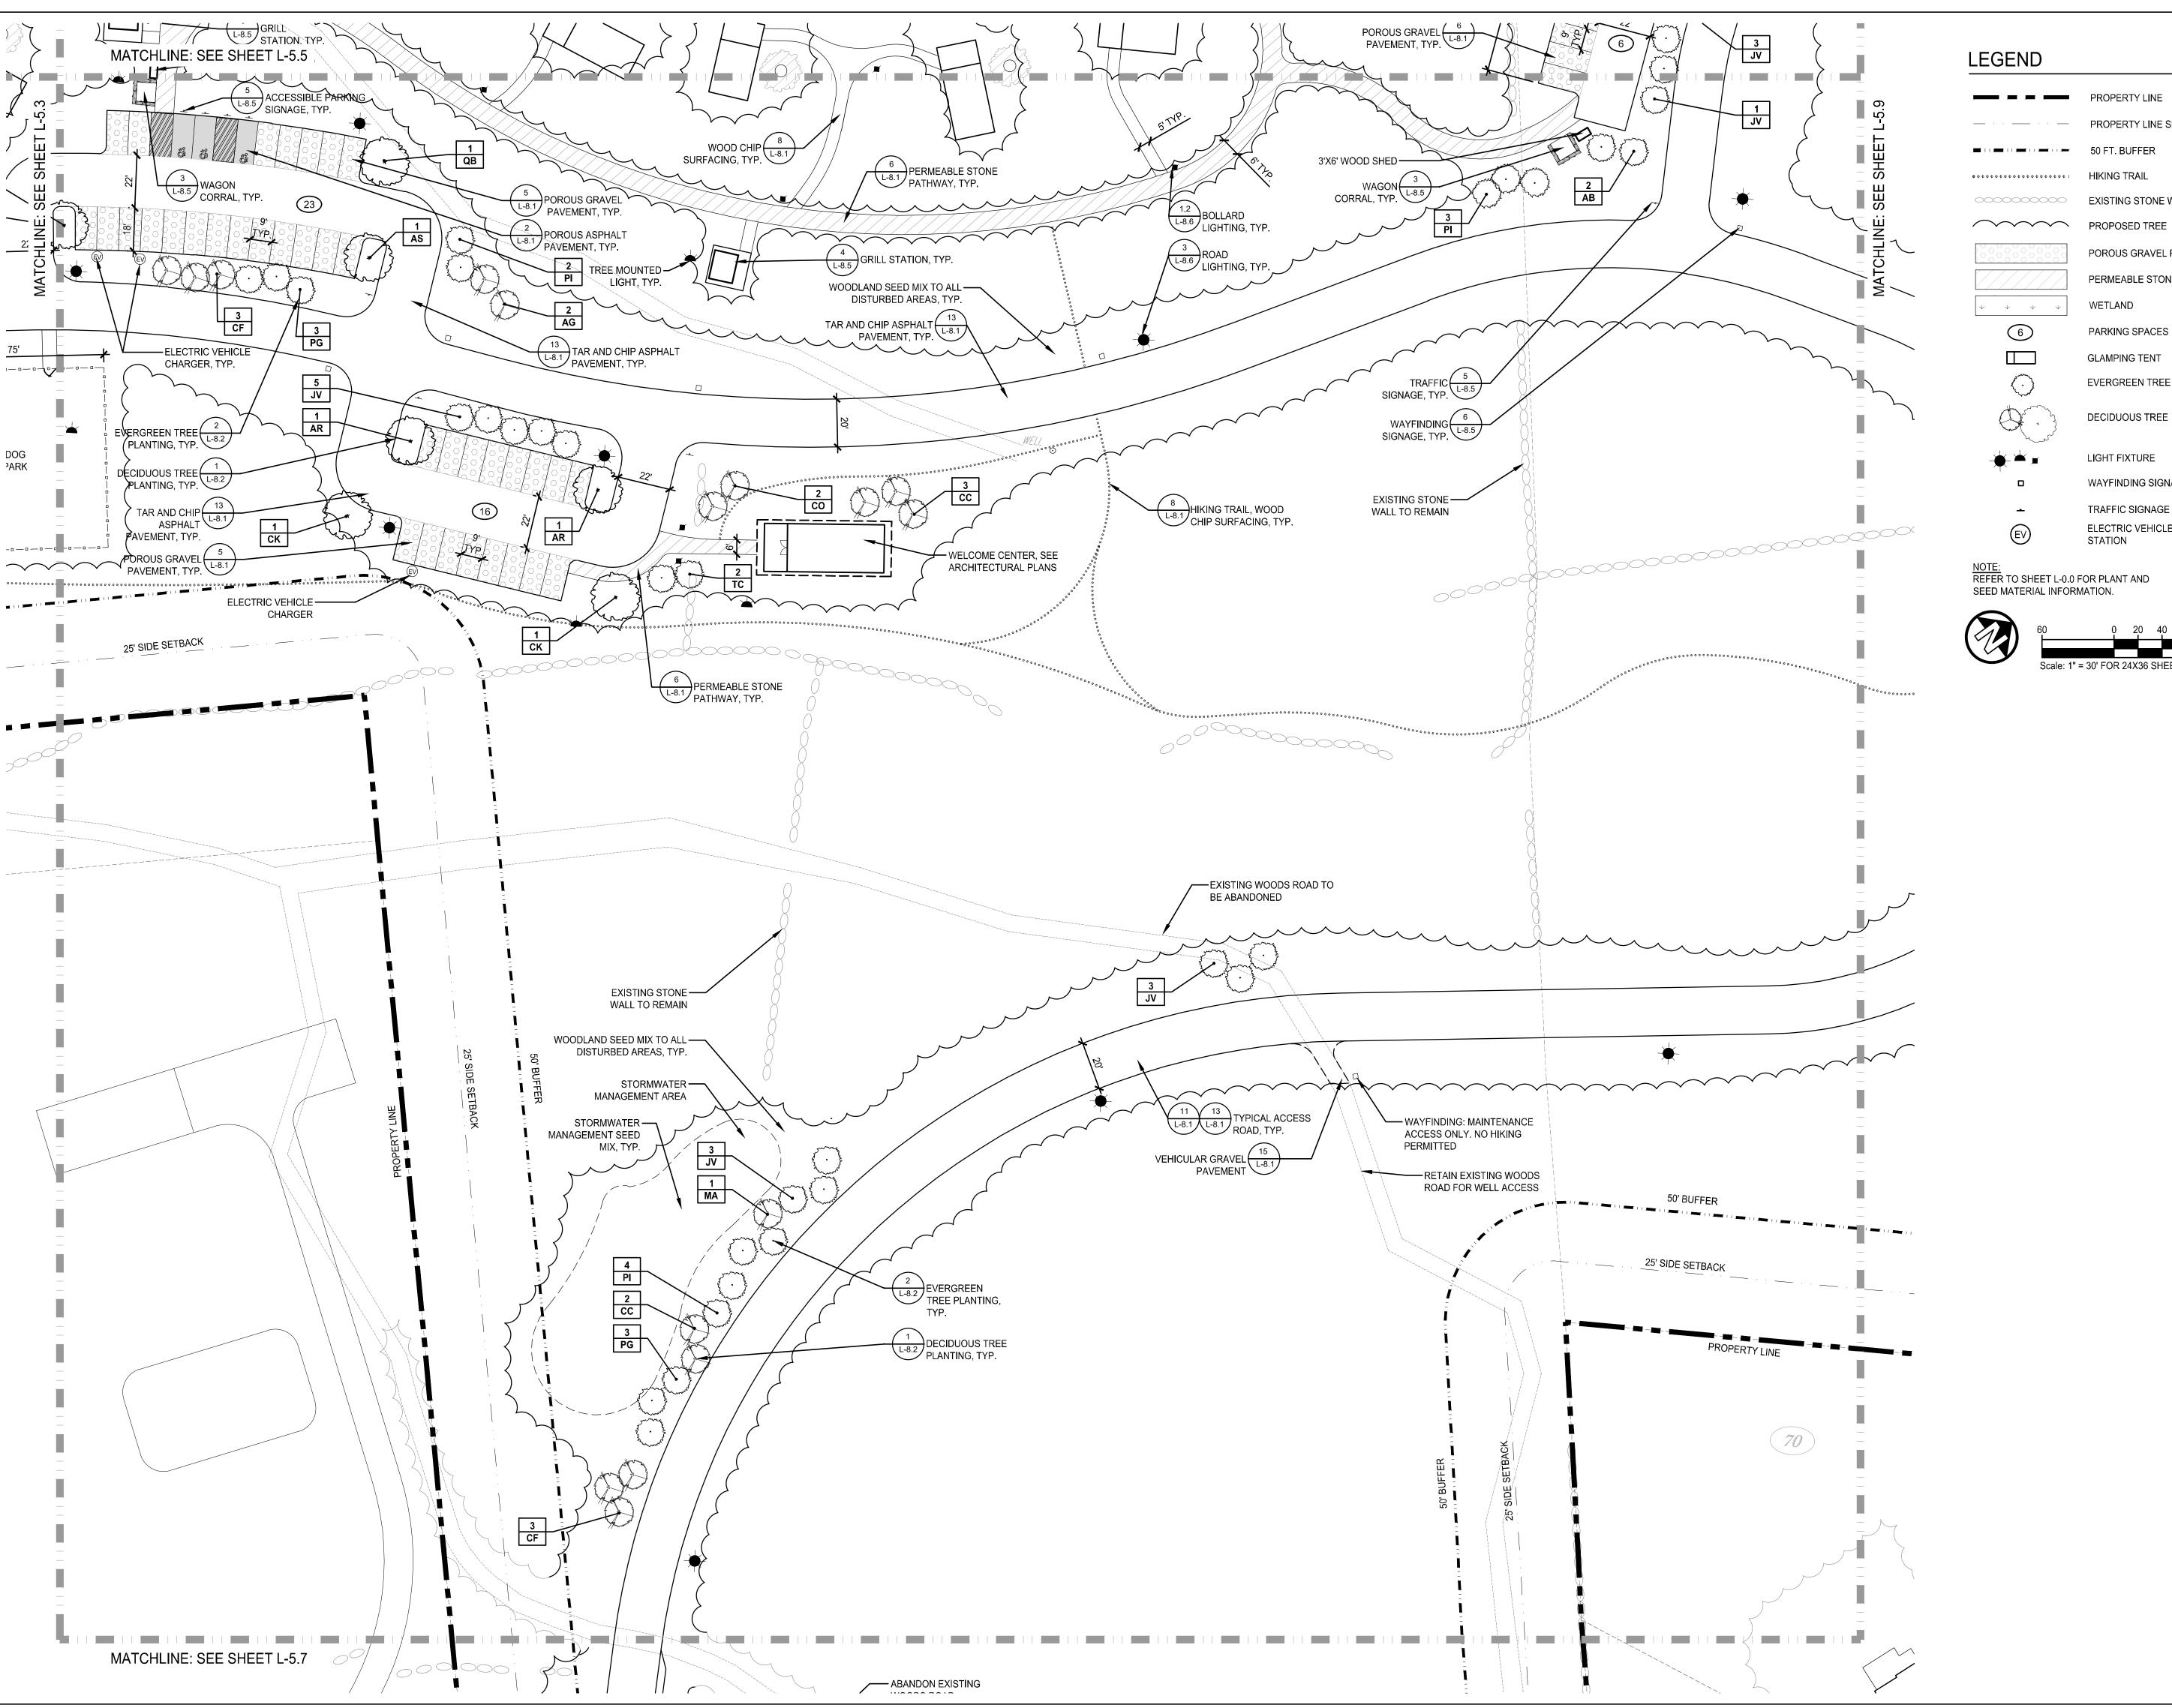

PROPERTY LINE PROPERTY LINE SETBACK

**─** · · **-** 50 FT. BUFFER

EXISTING STONE WALL PROPOSED TREE LINE

POROUS GRAVEL PAVING PERMEABLE STONE PATHWAY WETLAND


PARKING SPACES **GLAMPING TENT** 

**EVERGREEN TREE** 

LIGHT FIXTURE WAYFINDING SIGNAGE

TRAFFIC SIGNAGE ELECTRIC VEHICLE CHARGING STATION

NOTE: REFER TO SHEET L-0.0 FOR PLANT AND

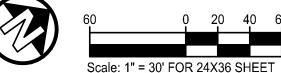

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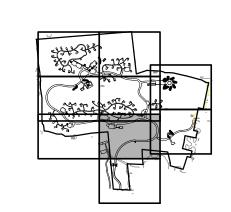
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Traffic Engineer: 80 Wolf Road, Suite 300, Albany, NY 12205

Surveyor: Ausfeld & Waldruff 323 Clinton Street Schenectady, NY 12305

**KEY MAP** 



Project Title:

Terramor Catskills

NY ROUTE 212 Saugerties, NY 12477

**ISSUED FOR:** SITE PLAN APPLICATION

BAS Ch'k'd: MJT 08/01/2022 Scale: 1"=30'

Description: A Review Comments 8/1/22

Drawing Title

LAYOUT, MATERIALS & PLANTING PLAN

Drawing No.



LEGEND

PROPERTY LINE PROPERTY LINE SETBACK **—** • • • • 50 FT. BUFFER

EXISTING STONE WALL

PROPOSED TREE LINE

POROUS GRAVEL PAVING PERMEABLE STONE PATHWAY WETLAND

> PARKING SPACES GLAMPING TENT **EVERGREEN TREE**

DECIDUOUS TREE

LIGHT FIXTURE WAYFINDING SIGNAGE TRAFFIC SIGNAGE

STATION

ELECTRIC VEHICLE CHARGING

NOTE: REFER TO SHEET L-0.0 FOR PLANT AND SEED MATERIAL INFORMATION.





People. Purpose. Place.

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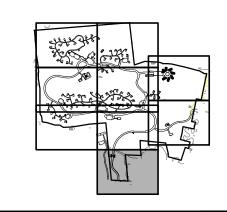
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**KEY MAP** 



Project Title:

Terramor Catskills

NY ROUTE 212 Saugerties, NY 12477

ISSUED FOR: SITE PLAN APPLICATION


BAS Ch'k'd: MJT 08/01/2022 Scale: 1"=30'


A Review Comments


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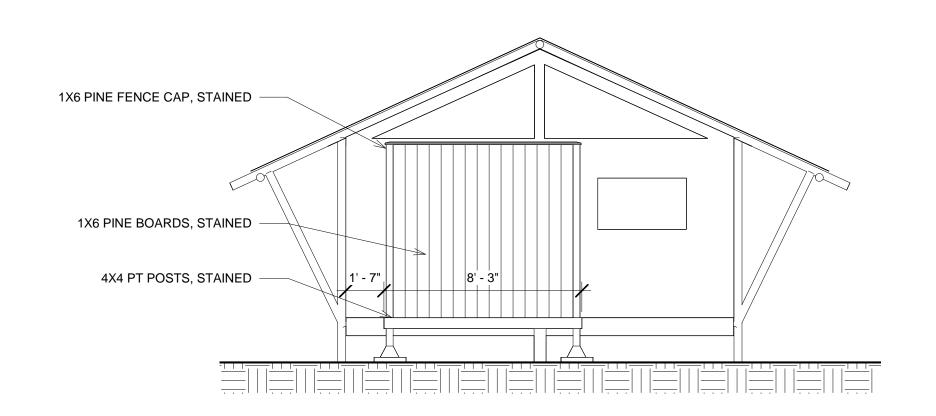
LAYOUT, MATERIALS & PLANTING PLAN

Drawing No.




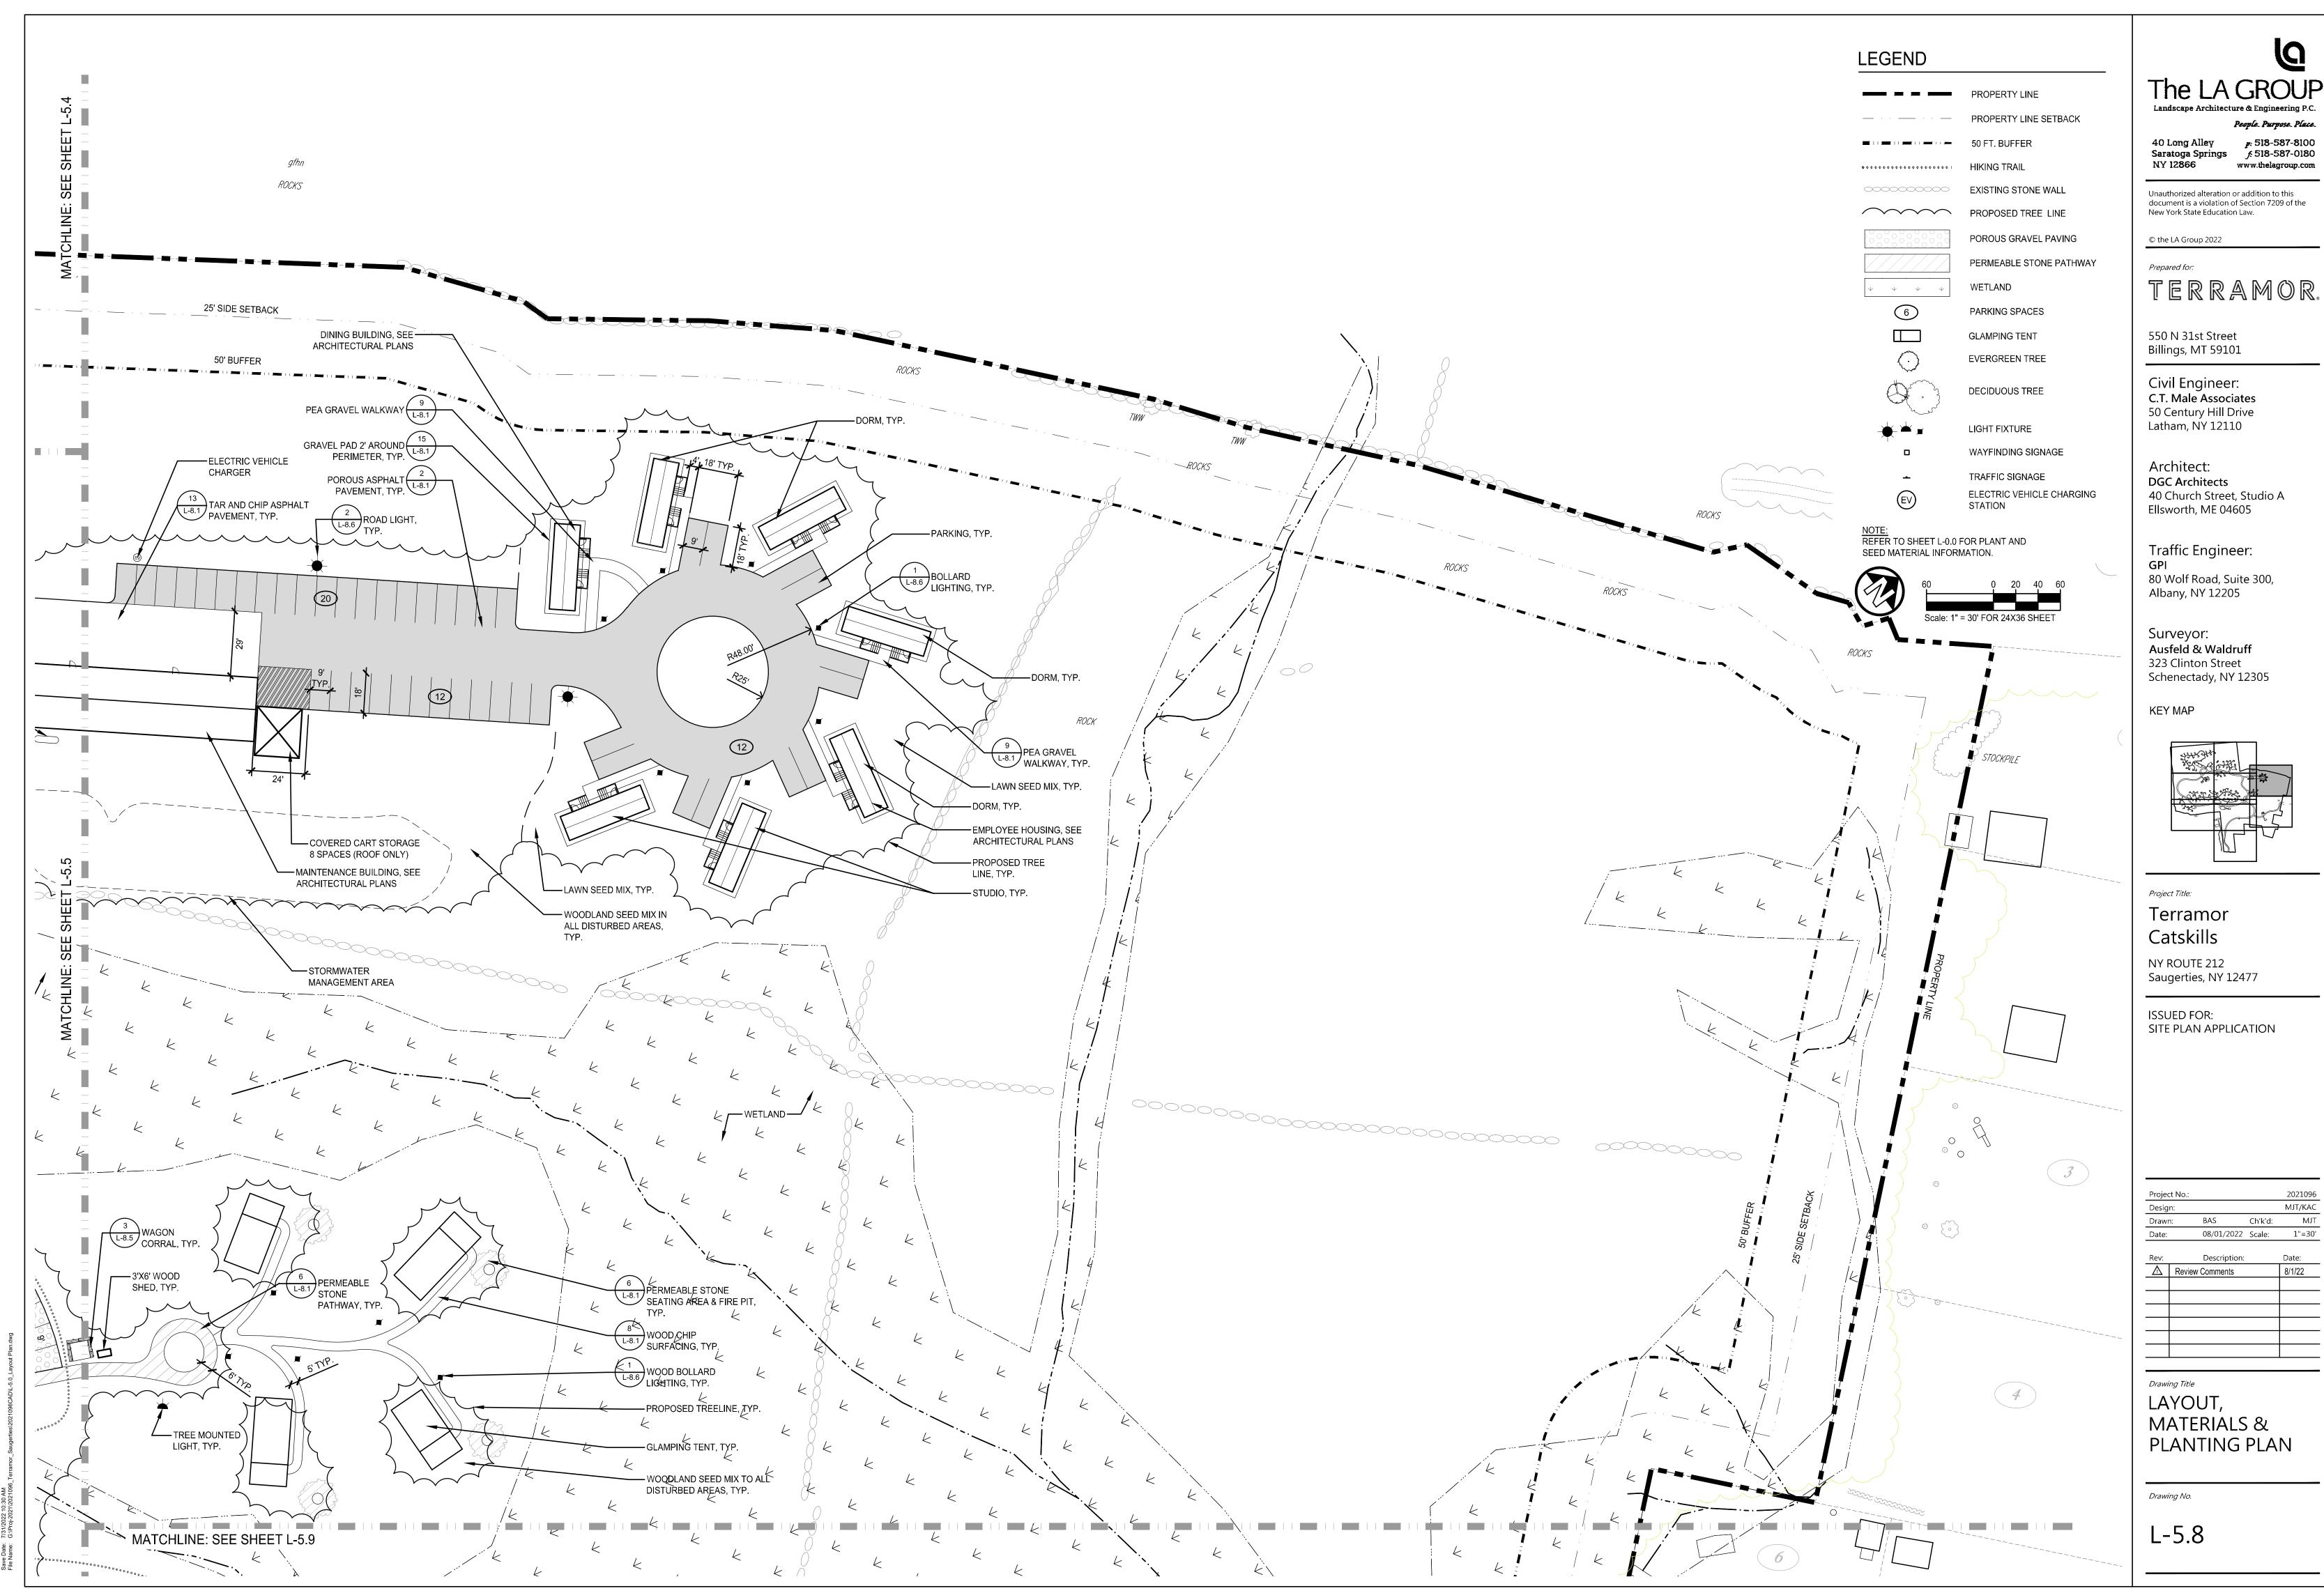


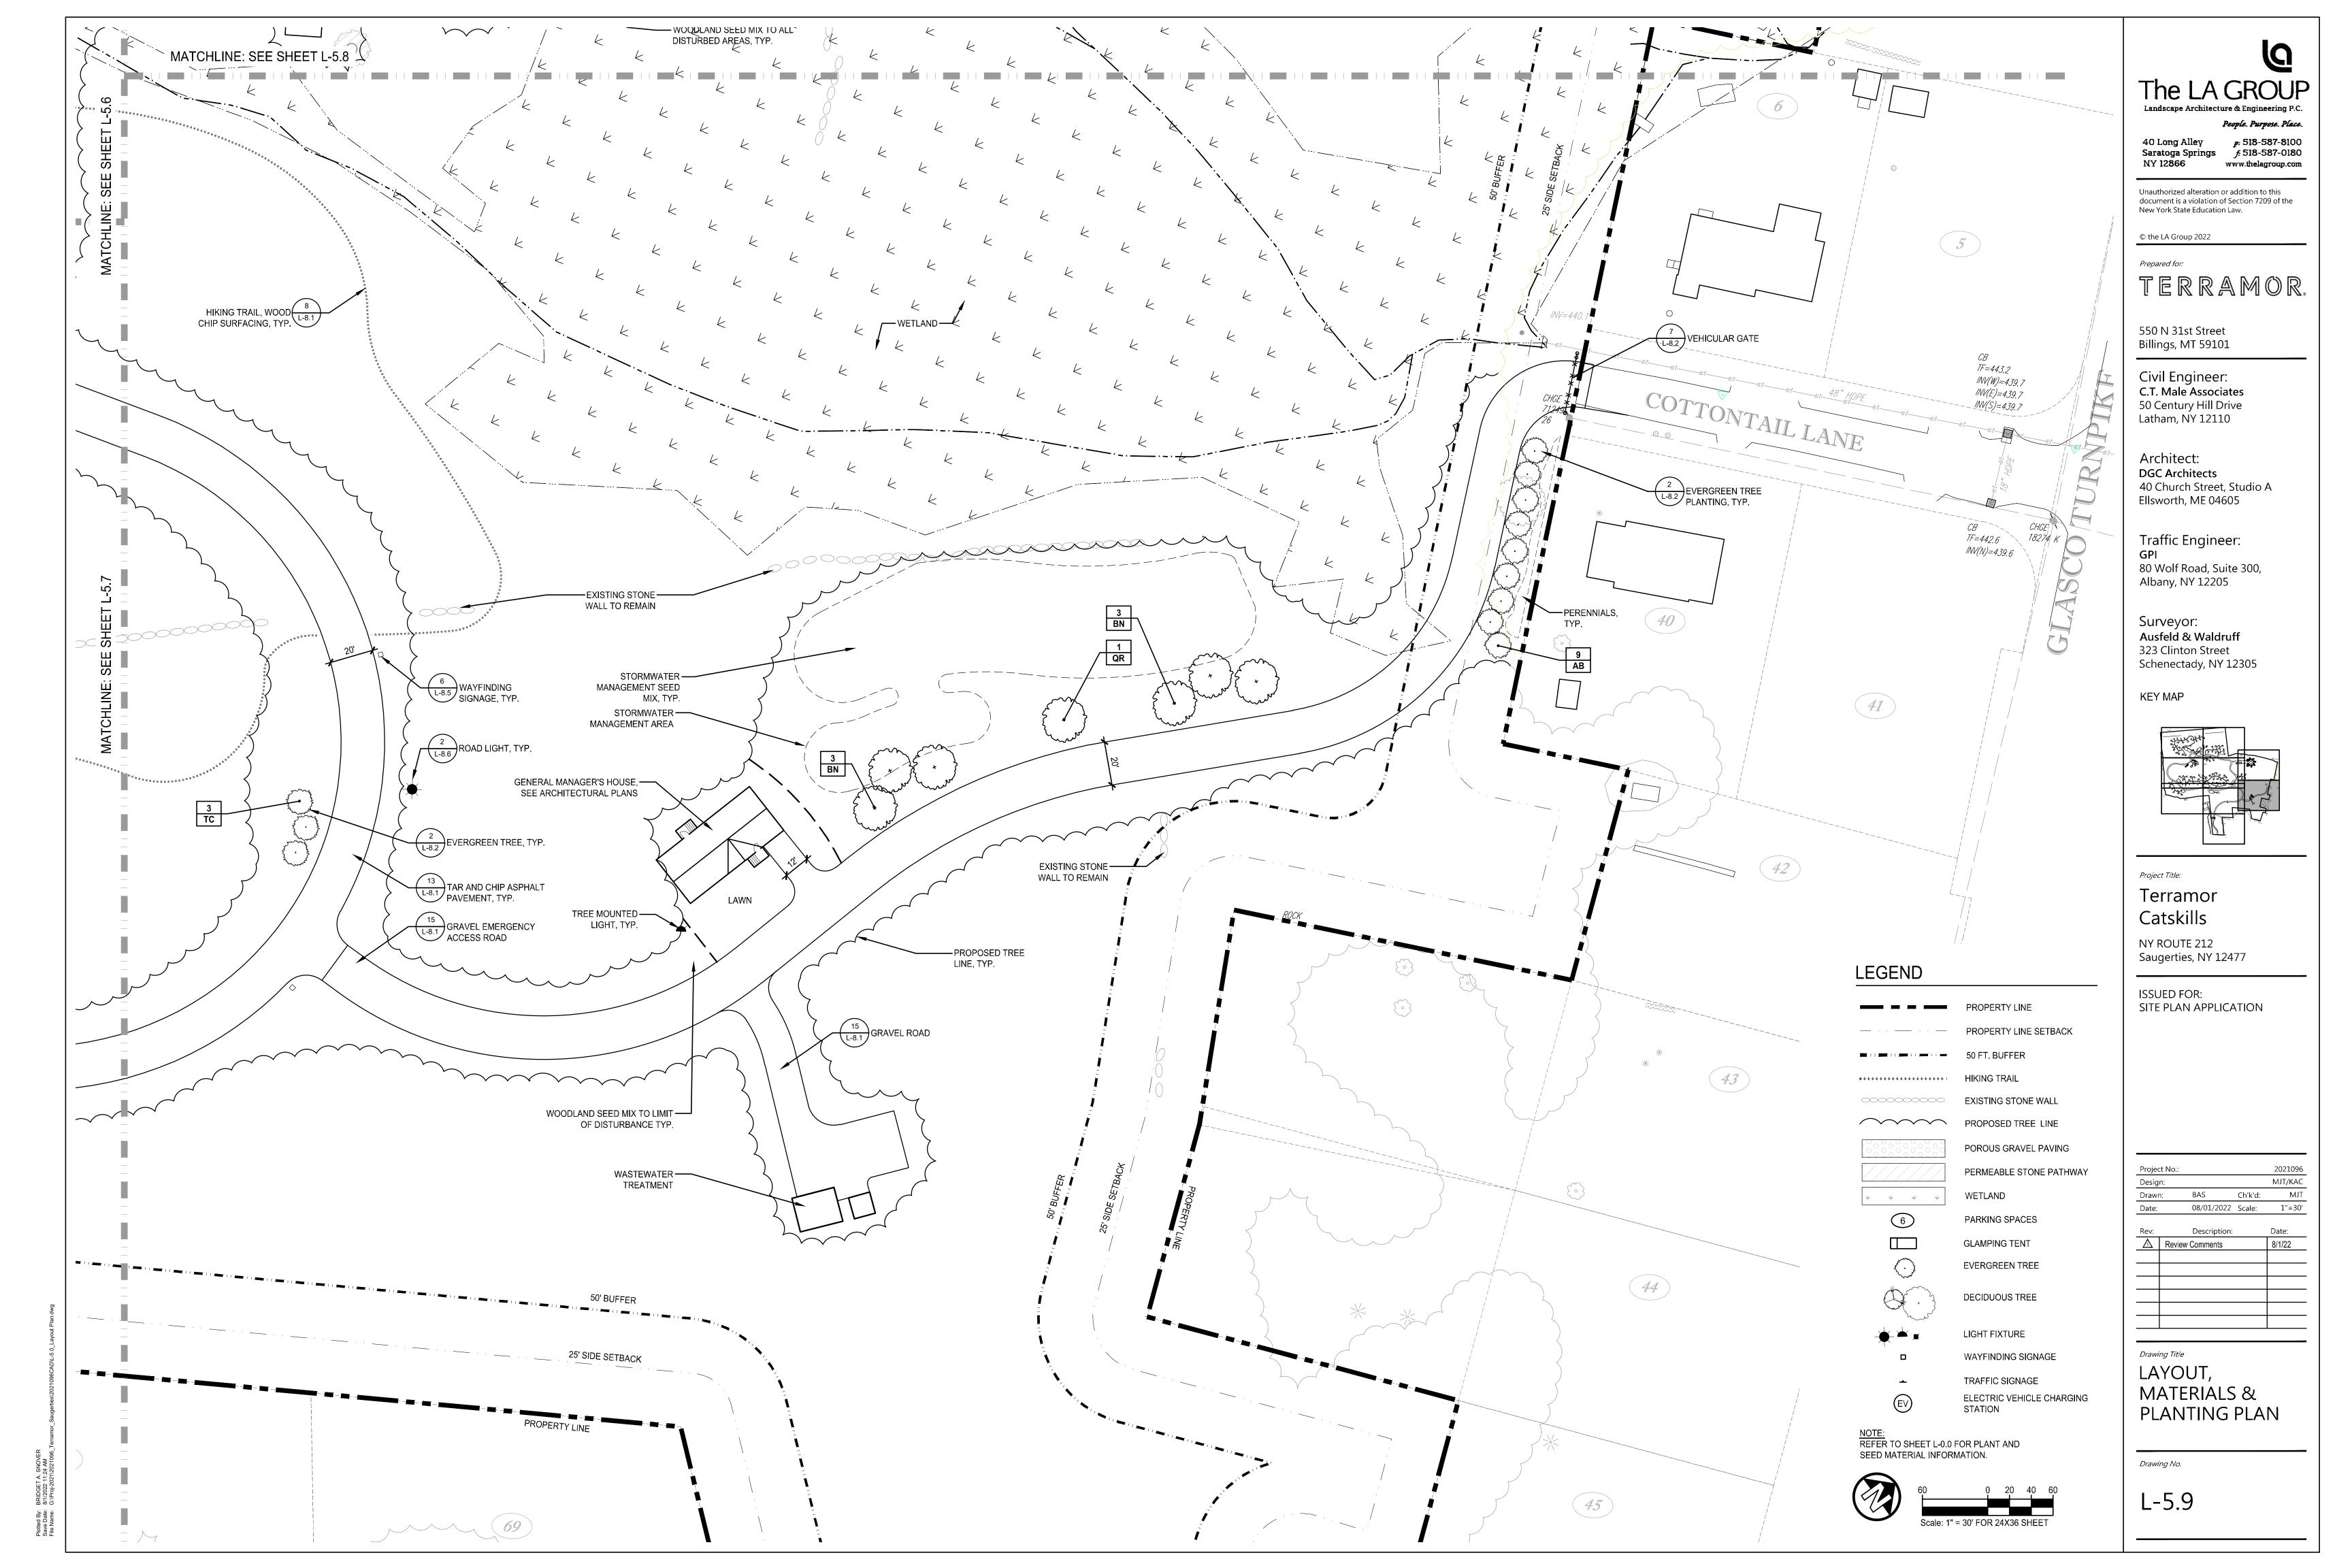


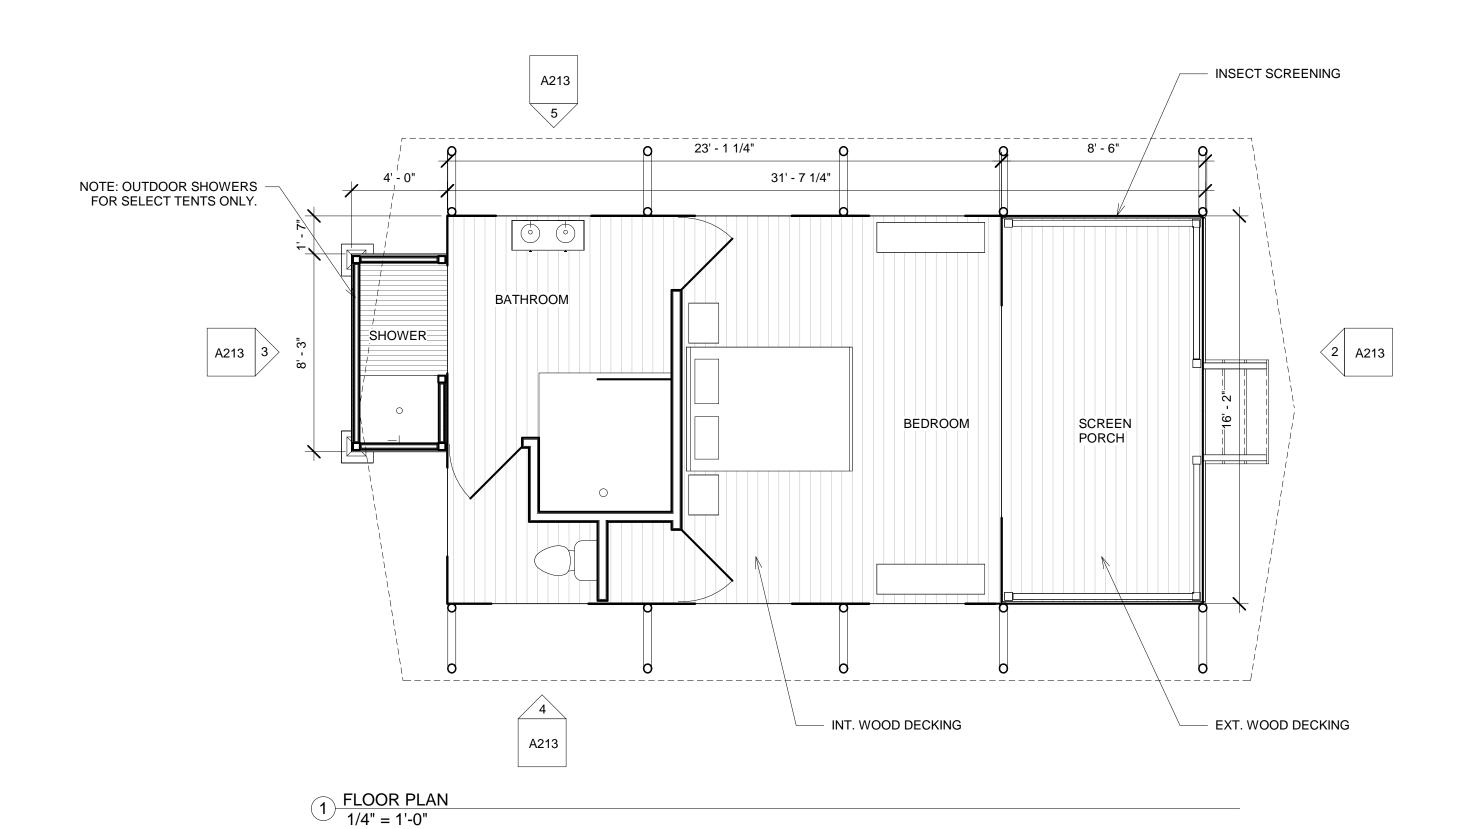

REAR ELEVATION
1/4" = 1'-0"

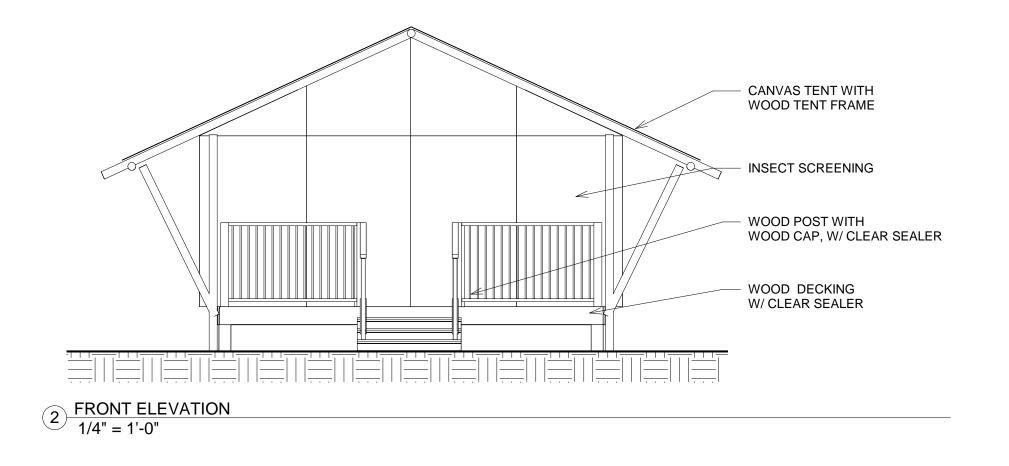

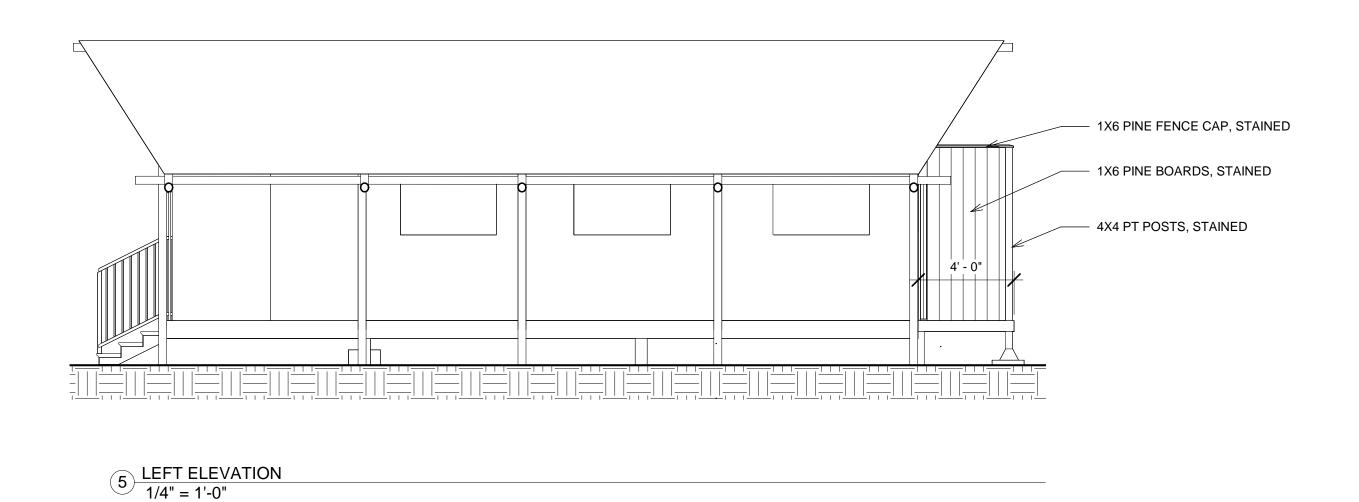

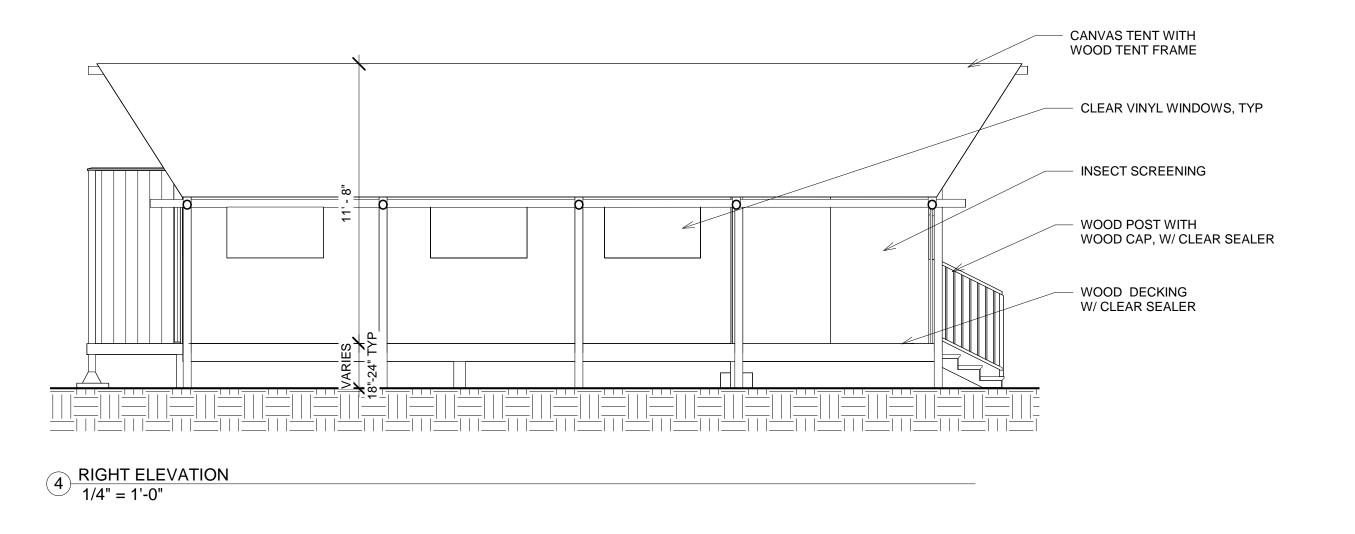

People. Purpose. Place. 40 Long Alley p: 518-587-8100
Saratoga Springs f: 518-587-0180
NY 12866 www.thelagroup.com

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Prepared for:

TERRAMOR.

OUTDOOR RESORT

550 N 31st Street

Billings, MT 59101

Civil Engineer: C.T. Male Associates 50 Century Hill Drive Latham, NY 12110

Architect: **DGC** Architects 40 Church Street, Studio A Ellsworth, ME 04605

Traffic Engineer: 80 Wolf Road, Suite 300, Albany, NY 12205

Surveyor: Ausfeld & Waldruff 323 Clinton Street Schenectady, NY 12305

Terramor Catskills

NY ROUTE 212 Saugerties, NY 12477


ISSUED FOR: SPECIAL USE / SITE PLAN APPLICATION


132109 Project No.: Drawn: MDW Ch'k'd: CMH Scale:  $1/4'' = \overline{1'-0''}$ Date: 7/28/2022 Description:

Drawing Title PLANS & **ELEVATIONS** 


**WOODY 35 TENT** 


Drawing No. A213

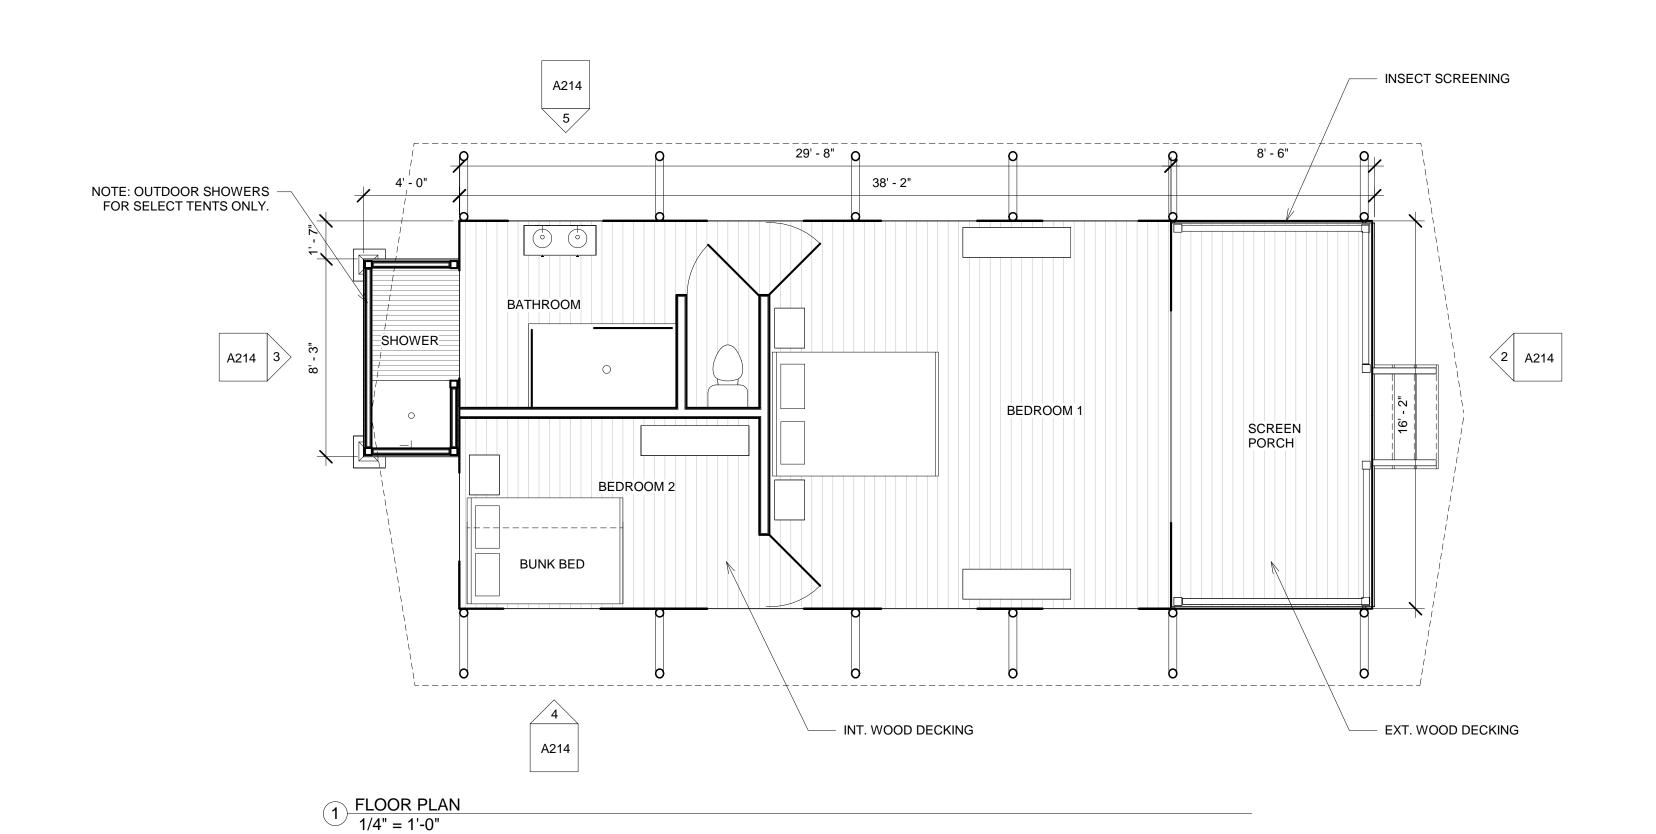


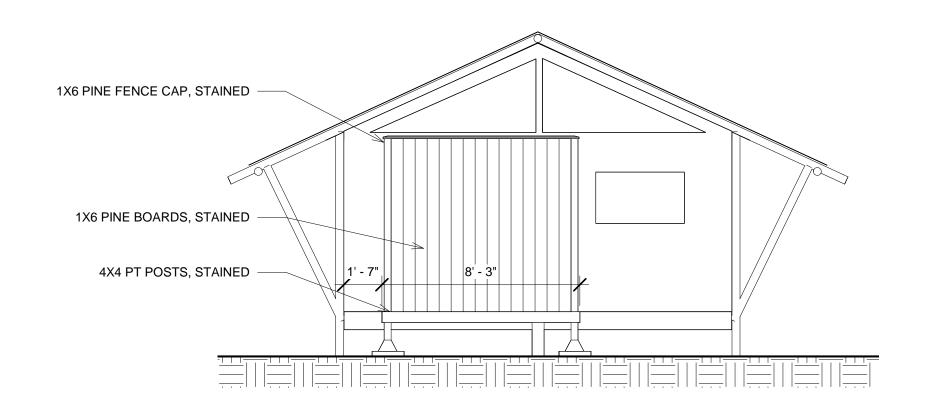

3 REAR ELEVATION 1/4" = 1'-0"

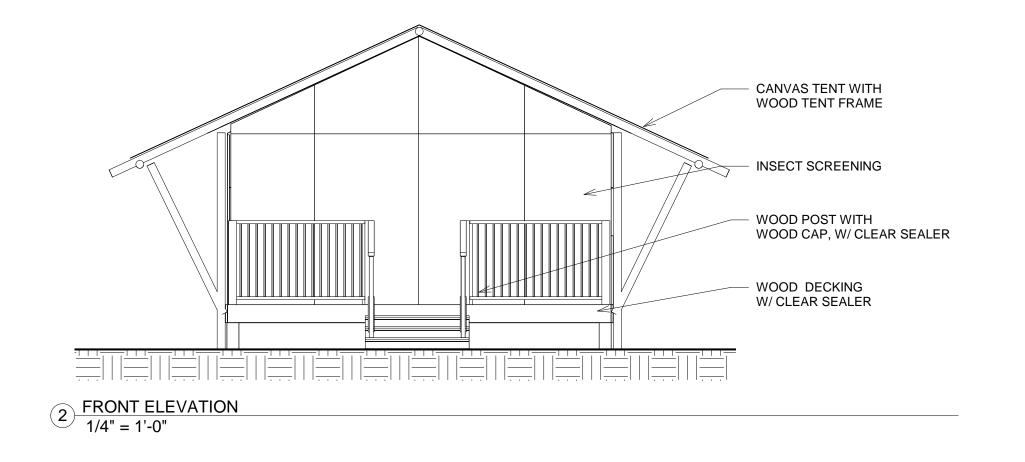

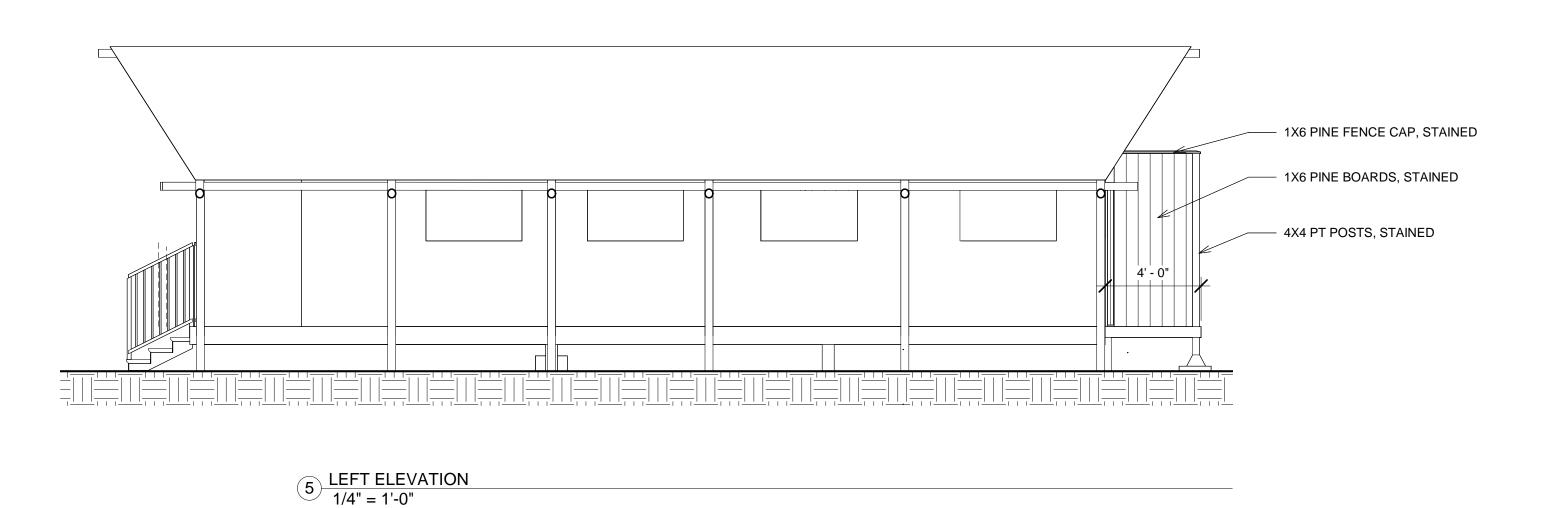

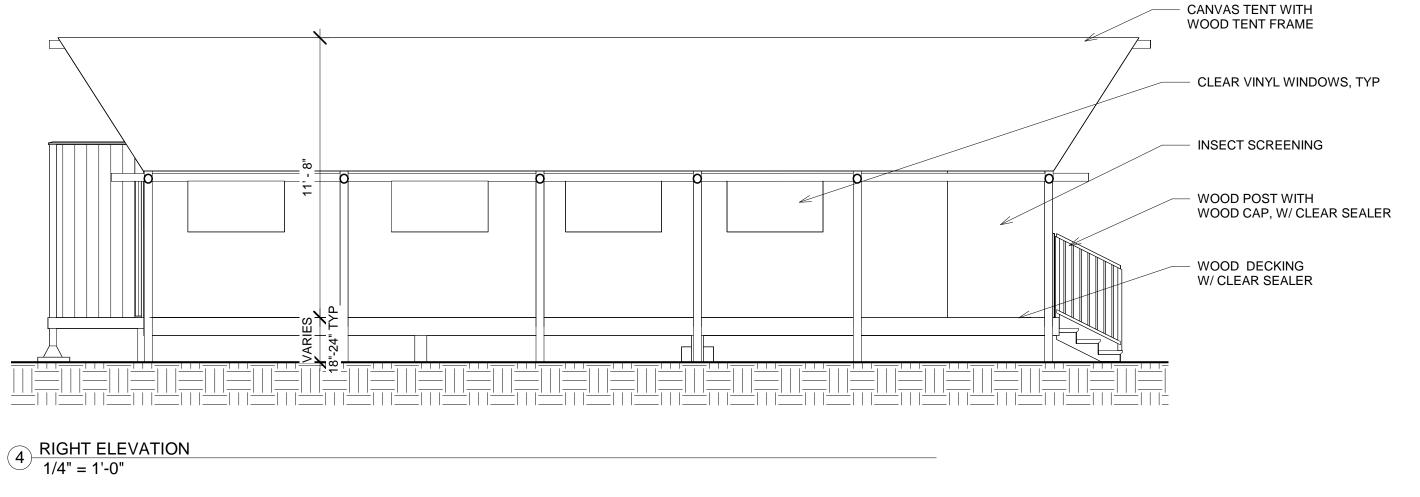

he LA GROUF

People. Purpose. Place.

40 Long Alley p: 518-587-8100
Saratoga Springs f: 518-587-0180
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Terramor Catskills

NY ROUTE 212 Saugerties, NY 12477

ISSUED FOR: SPECIAL USE / SITE PLAN APPLICATION

 Project No.:
 132109
 2021096

 Design:
 Drawn:
 MDW
 Ch'k'd:
 CMH

 Date:
 7/28/2022
 Scale:
 1/4" = 1'-0"

Rev: Description: Date:

PLANS & ELEVATIONS

Drawing Title

WOODY 45 TENT

Drawing No.
A214

TB-INFO.dwg insertion point